CUBBY PARK

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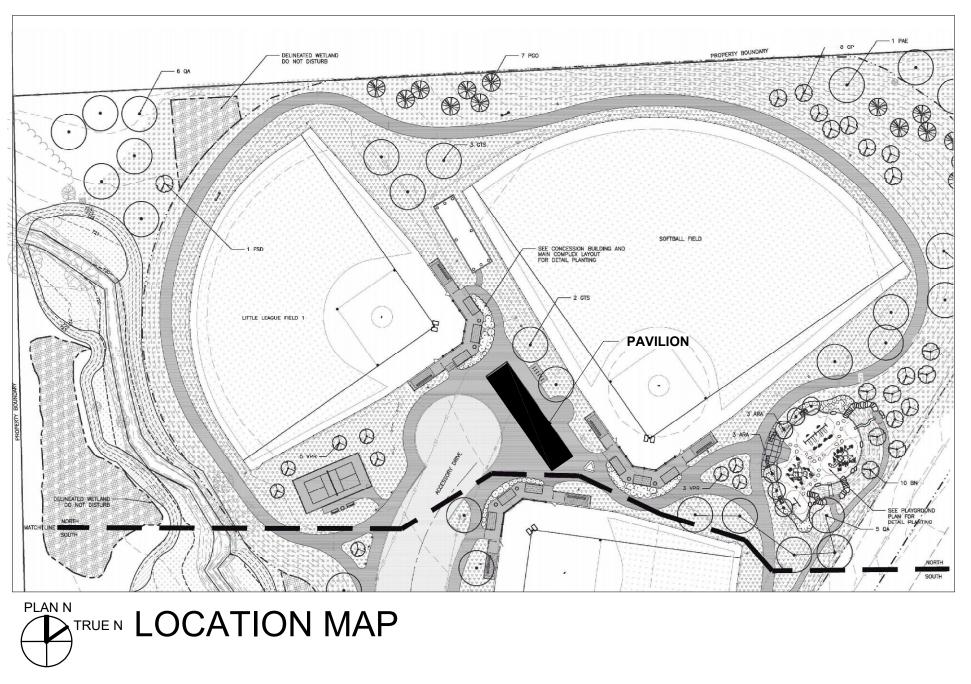
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FEHR GRAHAM 200 5TH AVENUE, SE SUITE 100 CEDAR RAPIDS, IOWA 52401 NATHAN KASS NKASS@FEHR-GRAHAM.COM 319-294-6909

DRAWING SHEET INDEX

SHEET NUMBER SHEET NAME

3-ARCHITE	CTURAL										
A000	COVER SHEET										
A100	1ST FLOOR PLAN										
A102	REFLECTED CEILING PLAN										
A200	SCHEDULES										
A400	EXTERIOR ELEVATIONS										
A401	EXTERIOR ELEVATIONS										
A500	INTERIOR ELEVATIONS										
A600	SECTIONS										
L100	LANDSCAPE PLAN										
4-STRUCTU	IRAL										
S100	FOUNDATION PLAN										
S101	ROOF FRAMING PLAN										
5-MECHANI	CAL										
M100	MECHANICAL PLAN										
P100	PLUMBING PLAN										
6-ELECTRIC	CAL										
E100	ELECTRICAL PLAN										



BUILDING CODES 2015 INTERNATIONAL BUILDING CODE 2015 INTERNATIONAL EXISTING BUILDING CODE 2009 INTERNATIONAL FIRE CODE 2014 NATIONAL ELECTRIC CODE 2015 INTERNATIONAL MECHANICAL CODE 2015 UNIFORM PLUMBING CODE 2012 INTERNATIONAL ENERGY CONSERVATION COD 2010 ADA STANDARDS	θE
CHAPTER 3 - USE AND OCCUPANCY BUILDING OCCUPANCY TYPE:	(A-2)
<u>CHAPTER 5 - GENERAL BUILDING HEIGHTS AND AREAS</u> TABLE 504.3 - ALLOWABLE BUILDING HEIGHT ALLOWABLE BUILDING HEIGHT: PROPOSED BUILDING HEIGHT:	(40 FT) (19' - 3/8")
TABLE 504.4 - ALLOABLE NUMBER OF STORIES ALLOWABLE NUMBER OF STORIES: PROPOSED NUMBER OF STORIES:	(1) (1)
SECTION 505.2.1 - AREA LIMITATIONS MEZZANINES SECTION 505.3 - EQUIPMENT PLATFORMS AREA	(NA) (NA)
TABLE 506.2 - ALLOWABLE AREA FACTOR IN S.F. PROPOSED ADDITION/NEW BUILDING CONSTRUCTION TYPE: ALLOWABLE BUILDING AREA/FLOOR:	(V-B) (6,000 S.F.)
SECTION 506 - BUILDING AND AREA MODIFICATIONS FRONTAGE INCREASE (.75) [I = .25 * W/30] SPRINKLER INCREASE (NA)	
TOTAL BUILDING PROPOSED AREA (MAIN FLOOR) PROPOSED AREA (OTHER FLOOR)	() (NA)
TOTAL ALLOWABLE BUILDING AREA (1	0,500 S.F.)
SECTION 507 - UNLIMITED AREA BUILDINGS	
TABLE 508.2.5 - INCIDENTAL ACCESSORY OCCUPAN	CIES (NA)
TABLE 508.4 - REQUIRED SEPARATION OF OCCUPAN	ICIES (NA)
CHAPTER 6 - TYPES OF CONSTRUCTIONTABLE 601 - FIRE RESISTANCE RATINGS FOR BUILDIPRIMARY STRUCTURAL FRAME(0)EXTERIOR BEARING WALLS(0)INTERIOR BEARING WALLS(0)NONBEARING WALLS(0)FLOORS(0)ROOFS(0)	NG ELEMENTS
<u>CHAPTER 9 - FIRE PROTECTION SYSTEMS</u> SECTION 903 - SPRINKER SYSTEM REQUIRED SECTION 907 - FIRE ALARM AND DETECTION SYSTEM	(NA) / (NA)
<u>CHAPTER 10 - MEANS OF EGRESS</u> SEE CALCULATED OCCPANCY LOAD OF PROJECT	
TABLE 1017.2 - EXIT ACCESS TRAVEL DISTANCE	(200 FT)
TABLE 1021.1 - MIN. NUMBER OF EXITS	

GENERAL NOTES:

1. ALL WORK ON THIS PROJECT IS TO BE BUILT IN COMPLIANCE WITH ALL STATE, FEDERAL, AND LOCAL BUILDING CODES. CONTRACTOR SHALL BREING TO ARCHITECT'S ATTENTION ALL ITEMS REQUIREING INTERPRETATION.

2. ALL CONTRACTORS ON THIS PROJECT MUST BE REGISTERED WITH THE STATE OF IOWA. GENERAL CONTRACTORS SHALL OBTAIN A COPY OF THE STATE REGISTRATION AND INSURANCE CERTIFICATES FROM EACH CONTRACTOR AND TRANSMIT TO ARCHITECT PRIOR TO START OF CONSTRUCTION.

3. HAZARDOUS MATERIALS: THE OWNER AT THIS TIME HAS NO KNOWLEDGE OF ASBESTOS OR ANY OTHER HAZARDOUS MATERIAL WITHIN OR ADJACENT TO THE EXISTING BUILDING. SHOULD THE CONTRACTOR OR ANY SUBCONTRACTOR ENCOUNTER MATERIAL WHICY THEY SUSPECT TO CONTAIN OR BE CONTAMINATED WITH ASBESTOS OR OTHER HAZARDOUS MATERIAL IN HAZARDOUS FORM, THEY SHOULD IMMEDIATELY CEASE ALL OPERATIONS IN THE AREA OF THE SUSPECTED MATERIAL AND NOTIFY THE OWNER AND CONFIRM THE NOTIFICATION IN WRITING ONCE NOTIFIED, THE OWNER SHALL BE RESPONSIBLE FOR TESTING AND REMOVAL AS NEEDED.

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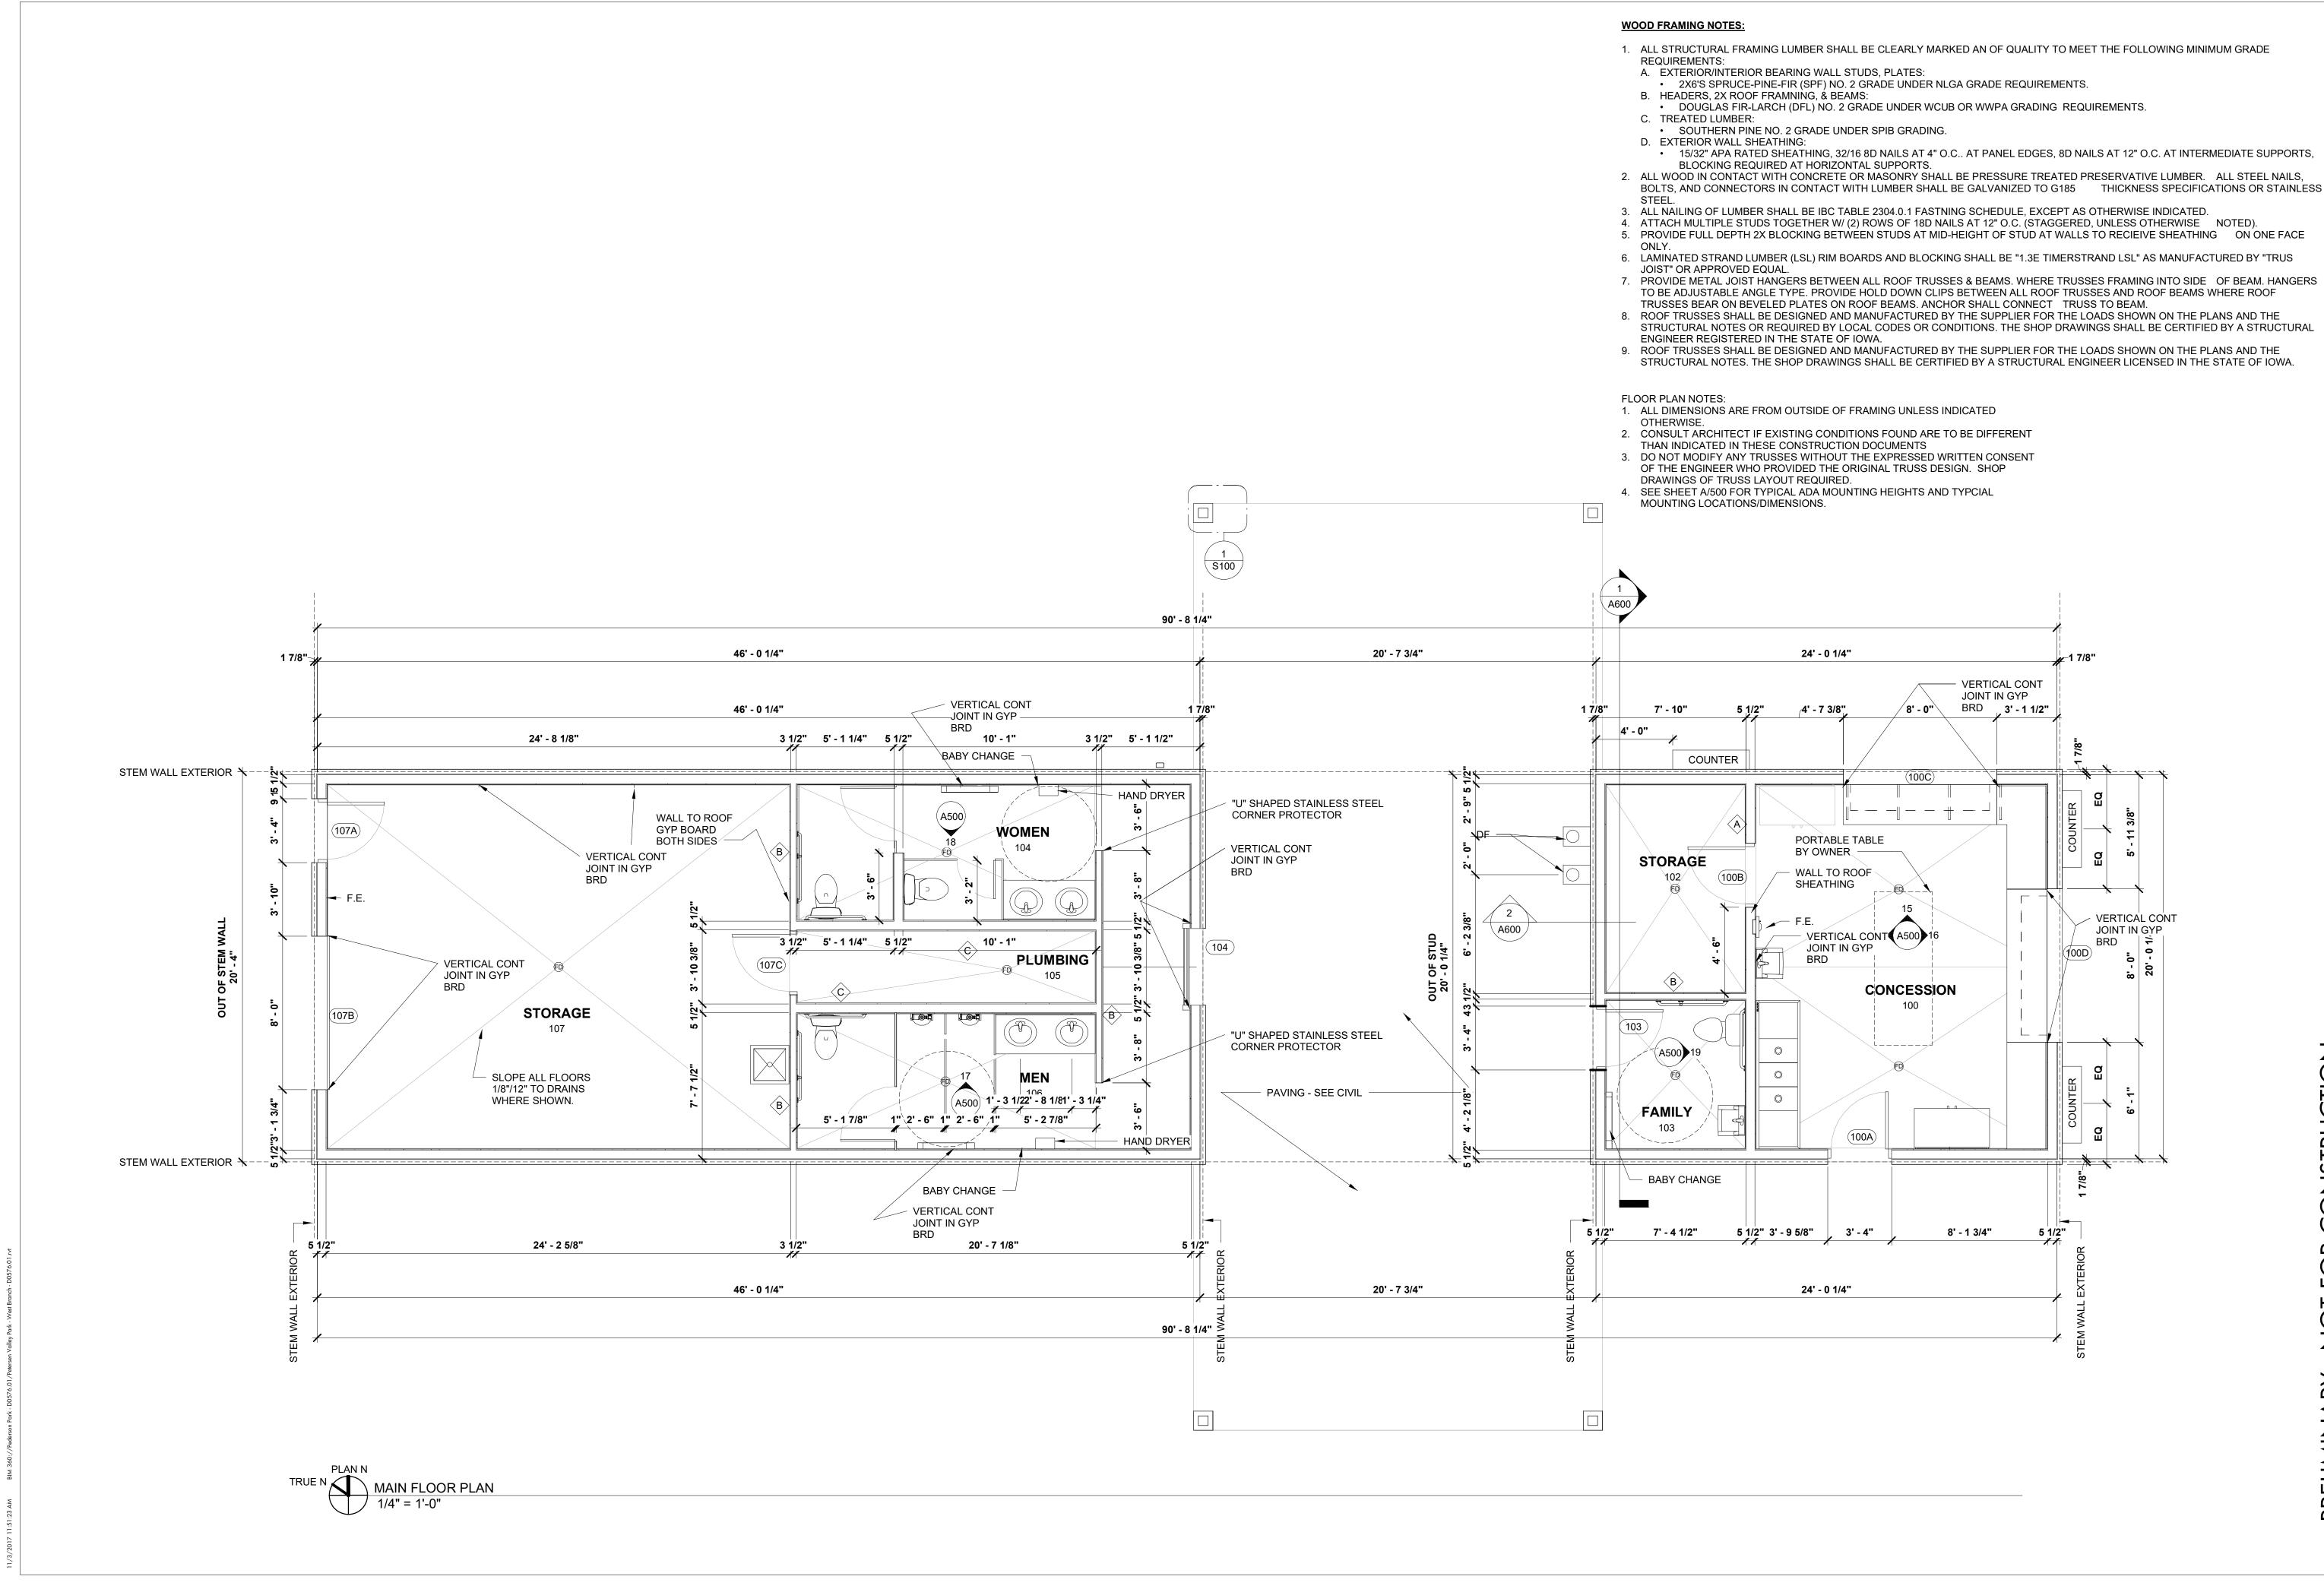
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2. ALL WOOD IN CONTACT WITH CONCRETE OR MASONRY SHALL BE PRESSURE TREATED PRESERVATIVE LUMBER. ALL STEEL NAILS, BOLTS, AND CONNECTORS IN CONTACT WITH LUMBER SHALL BE GALVANIZED TO G185 THICKNESS SPECIFICATIONS OR STAINLESS

TO BE ADJUSTABLE ANGLE TYPE. PROVIDE HOLD DOWN CLIPS BETWEEN ALL ROOF TRUSSES AND ROOF BEAMS WHERE ROOF

STRUCTURAL NOTES OR REQUIRED BY LOCAL CODES OR CONDITIONS. THE SHOP DRAWINGS SHALL BE CERTIFIED BY A STRUCTURAL

STRUCTURAL NOTES. THE SHOP DRAWINGS SHALL BE CERTIFIED BY A STRUCTURAL ENGINEER LICENSED IN THE STATE OF IOWA.

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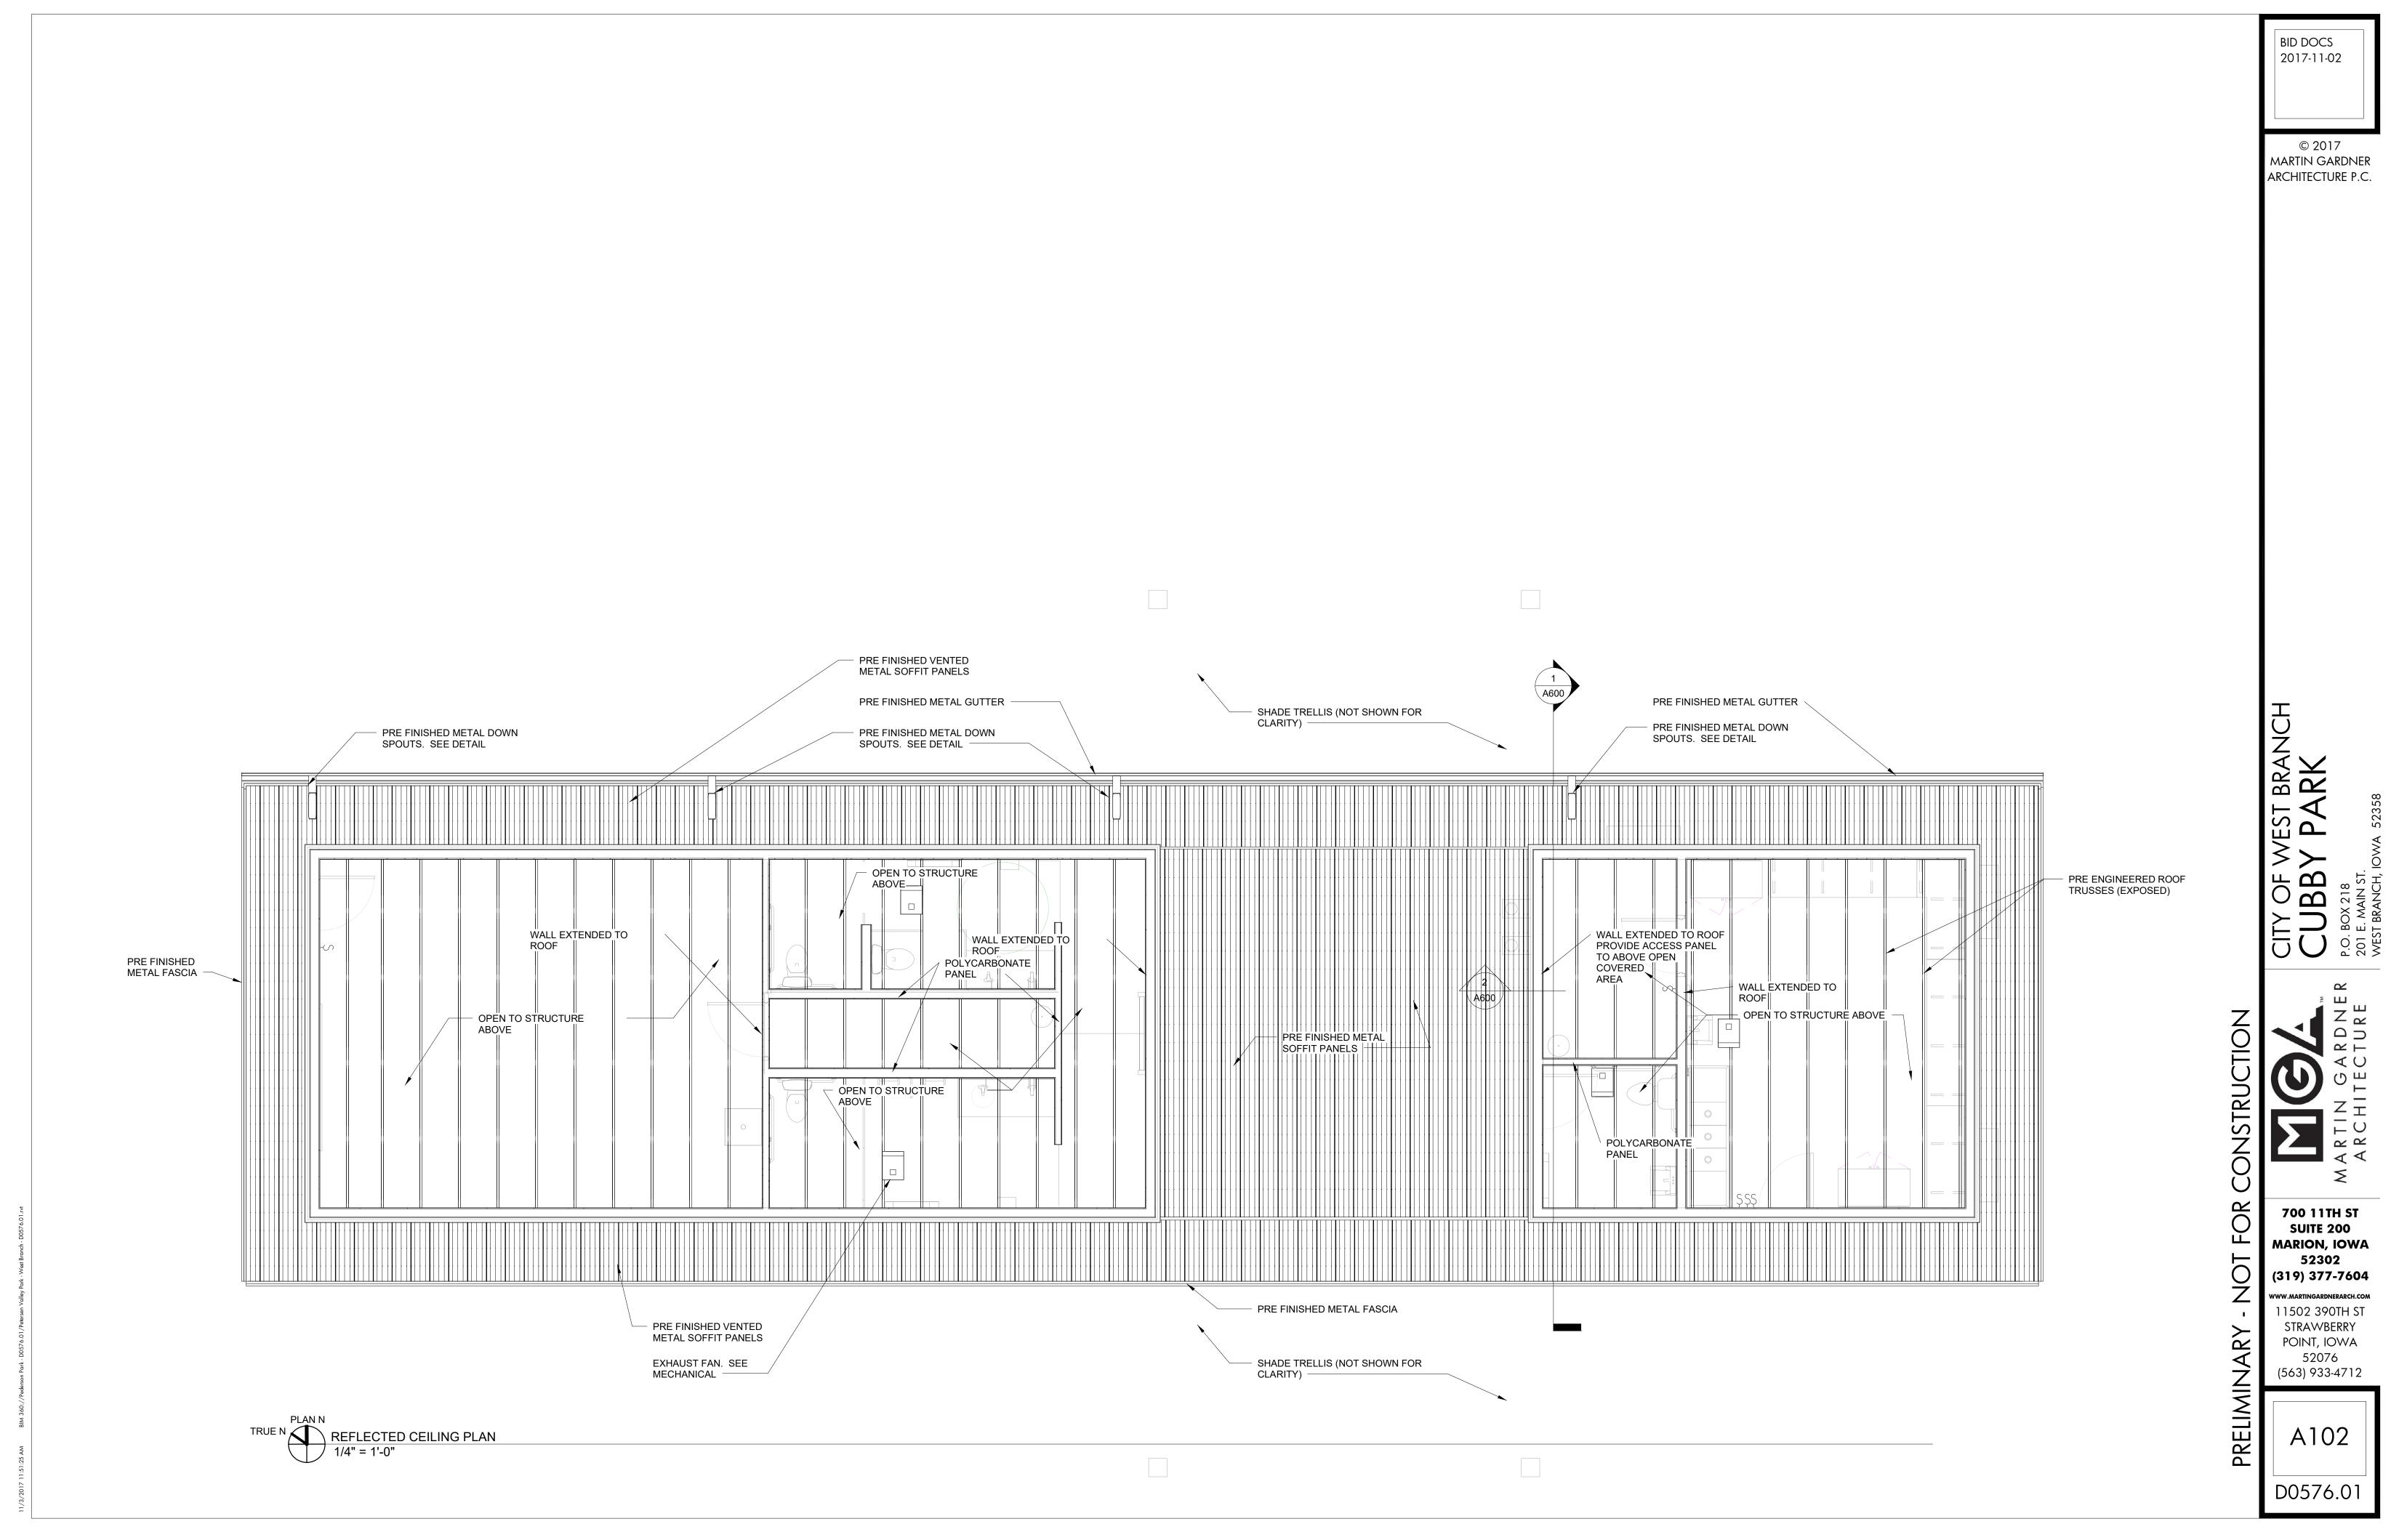
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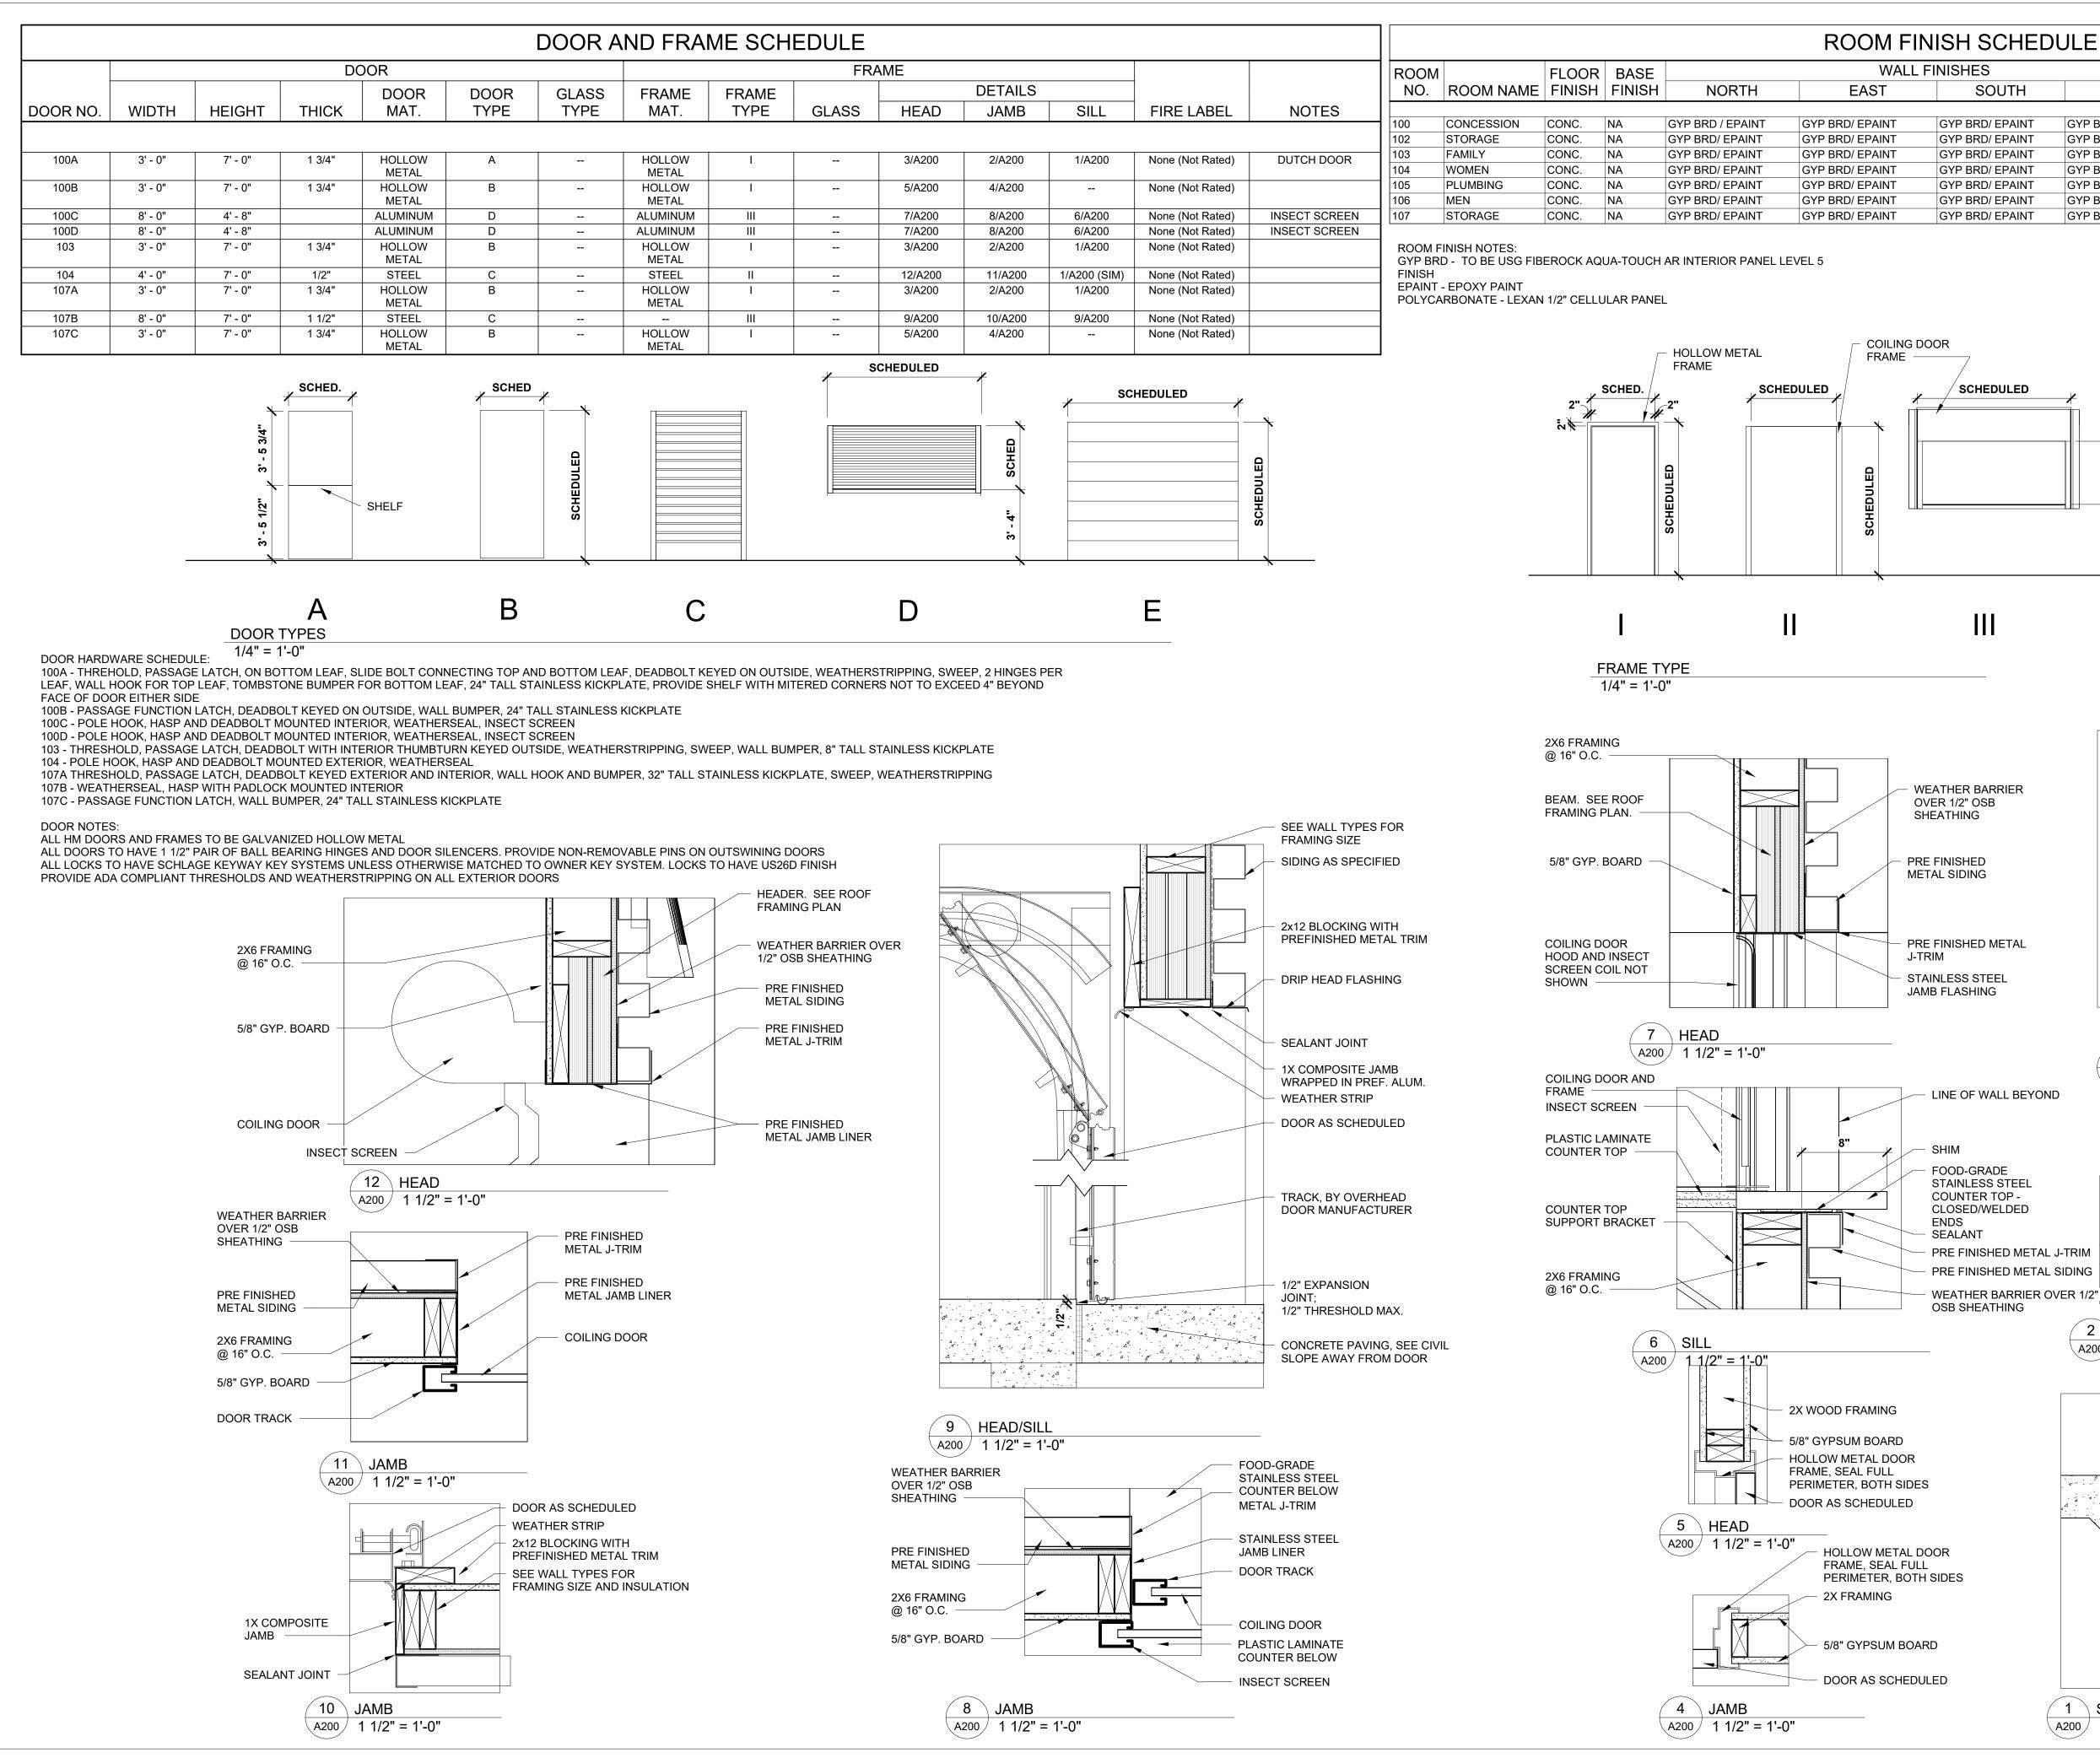
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	SOUTH	WEST	CEILING FINIISH	HT.	COMMENTS		
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	GYP BRD/ EPAINT	GYP BRD/ EPAINT	NA			-	
NT T	GYP BRD/ EPAINT	GYP BRD/ EPAINT	NA			-	© 2017
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ILING D	SCHEDULED	SCHED					
O'SI	/EATHER BARRIER VER 1/2" OSB HEATHING E FINISHED TAL SIDING		MIL VAPOR 2x6 WOOD I AIR BARRIE SHEATHING	FRAMING R OVER 1/2" S EE STRUCTURA			

PREFINISHED FLASHING WITH

DRIP AND END DAMNS

HOLLOW METAL DOOR

DOOR AS SCHEDULED

PERIMETER, BOTH SIDES


FRAME, SEAL FULL

2 JAMB


3 HEAD

A200 1 1/2" = 1'-0" HOLLOW METAL DOOR FRAME, SEAL FULL PERIMETER, BOTH SIDES 5/8" GYPSUM BOARD OVER 4 MIL VAPOR BARRIER 2x6 WOOD FRAMING DOOR AS SCHEDULED AIR BARRIER OVER 1/2" SHEATHING SIDING AS SPECIFIED SIDING EDGE FLASHING A200/ 1 1/2" = 1'-0" DOOR AS SCHEDULED DOOR THRESHOLD MAXIMUM HEIGHT 1/2", SET IN TWO CONTINUOUS BEADS OF SEALANT 1/2" EXPANSION JOINT POURED IN PLACE CONCRETE, SEE STRUCTURAL POURED IN PLACE FROST STOOP, SEE STRUCTURAL POURED IN PLACE FOUNDATION WALL, SEE STRUCTURAL .44 $1 \setminus SILL$ A200/ 1 1/2" = 1'-0"




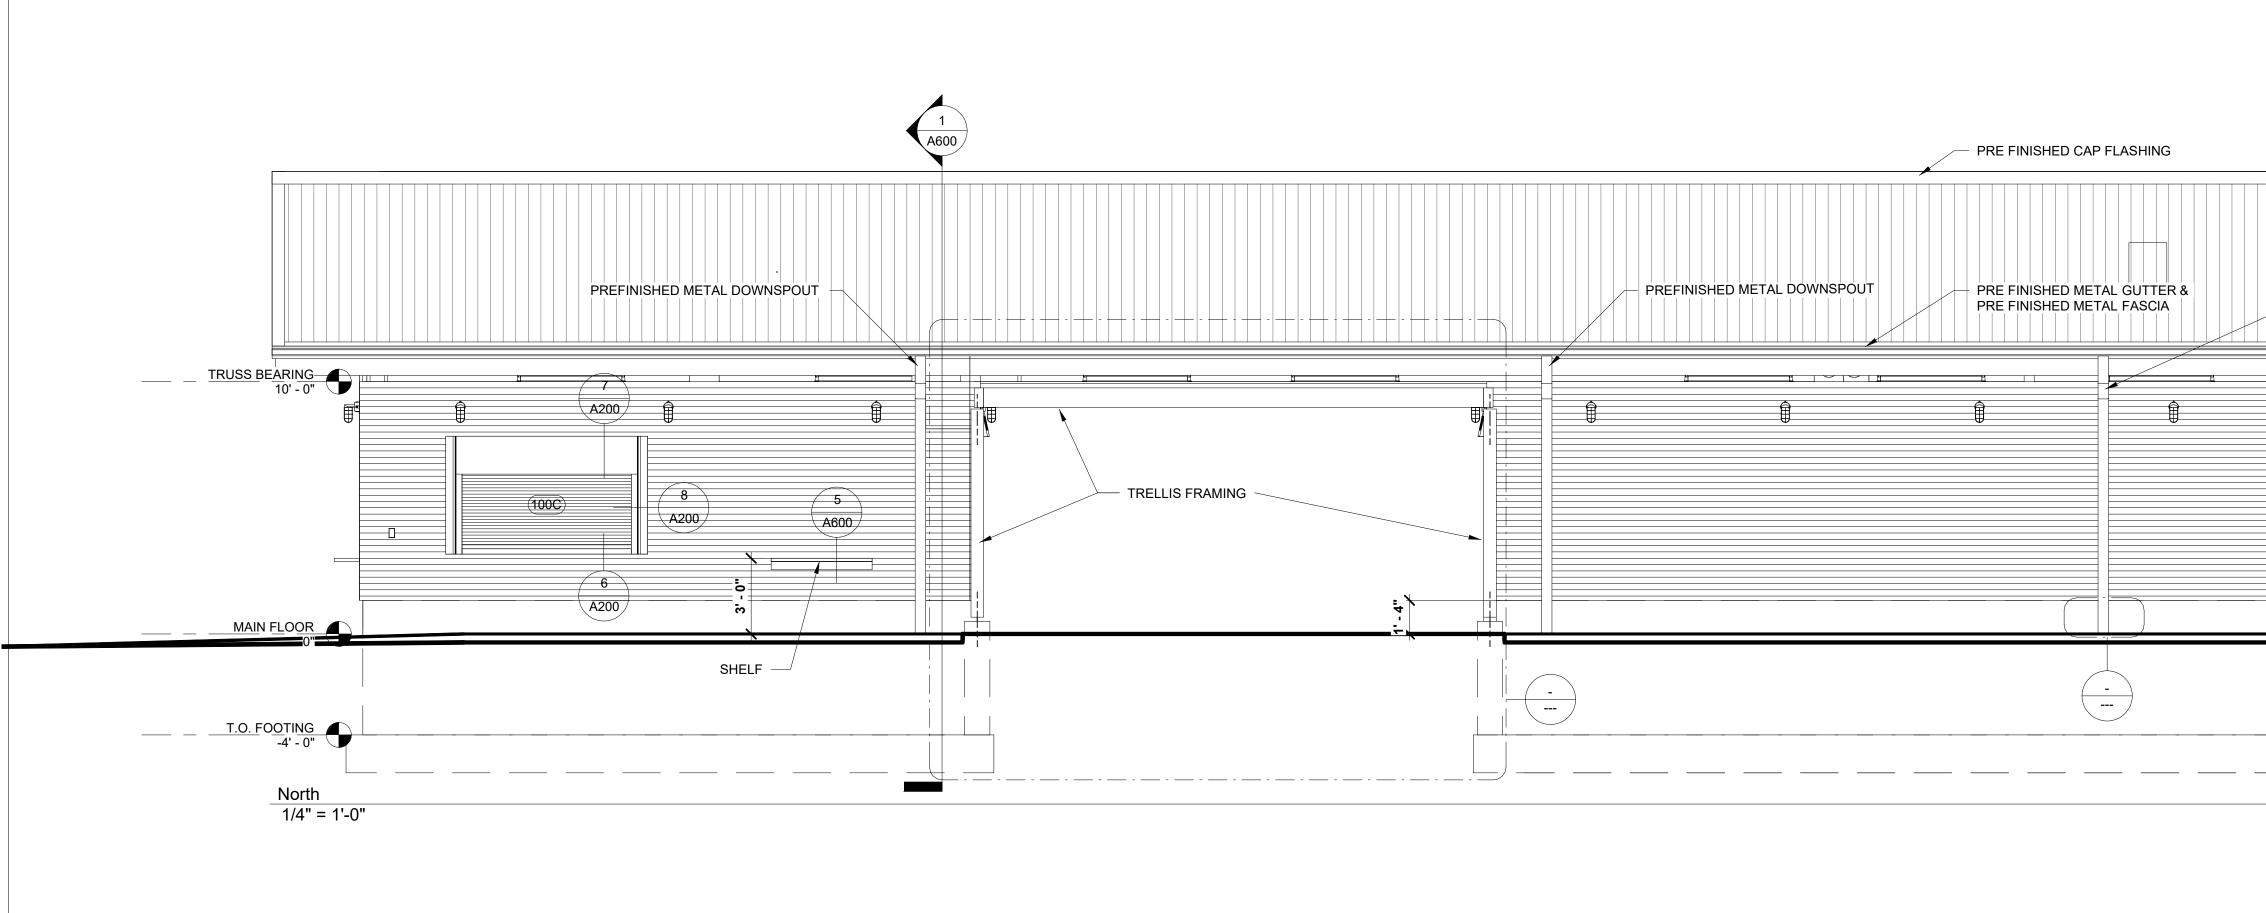




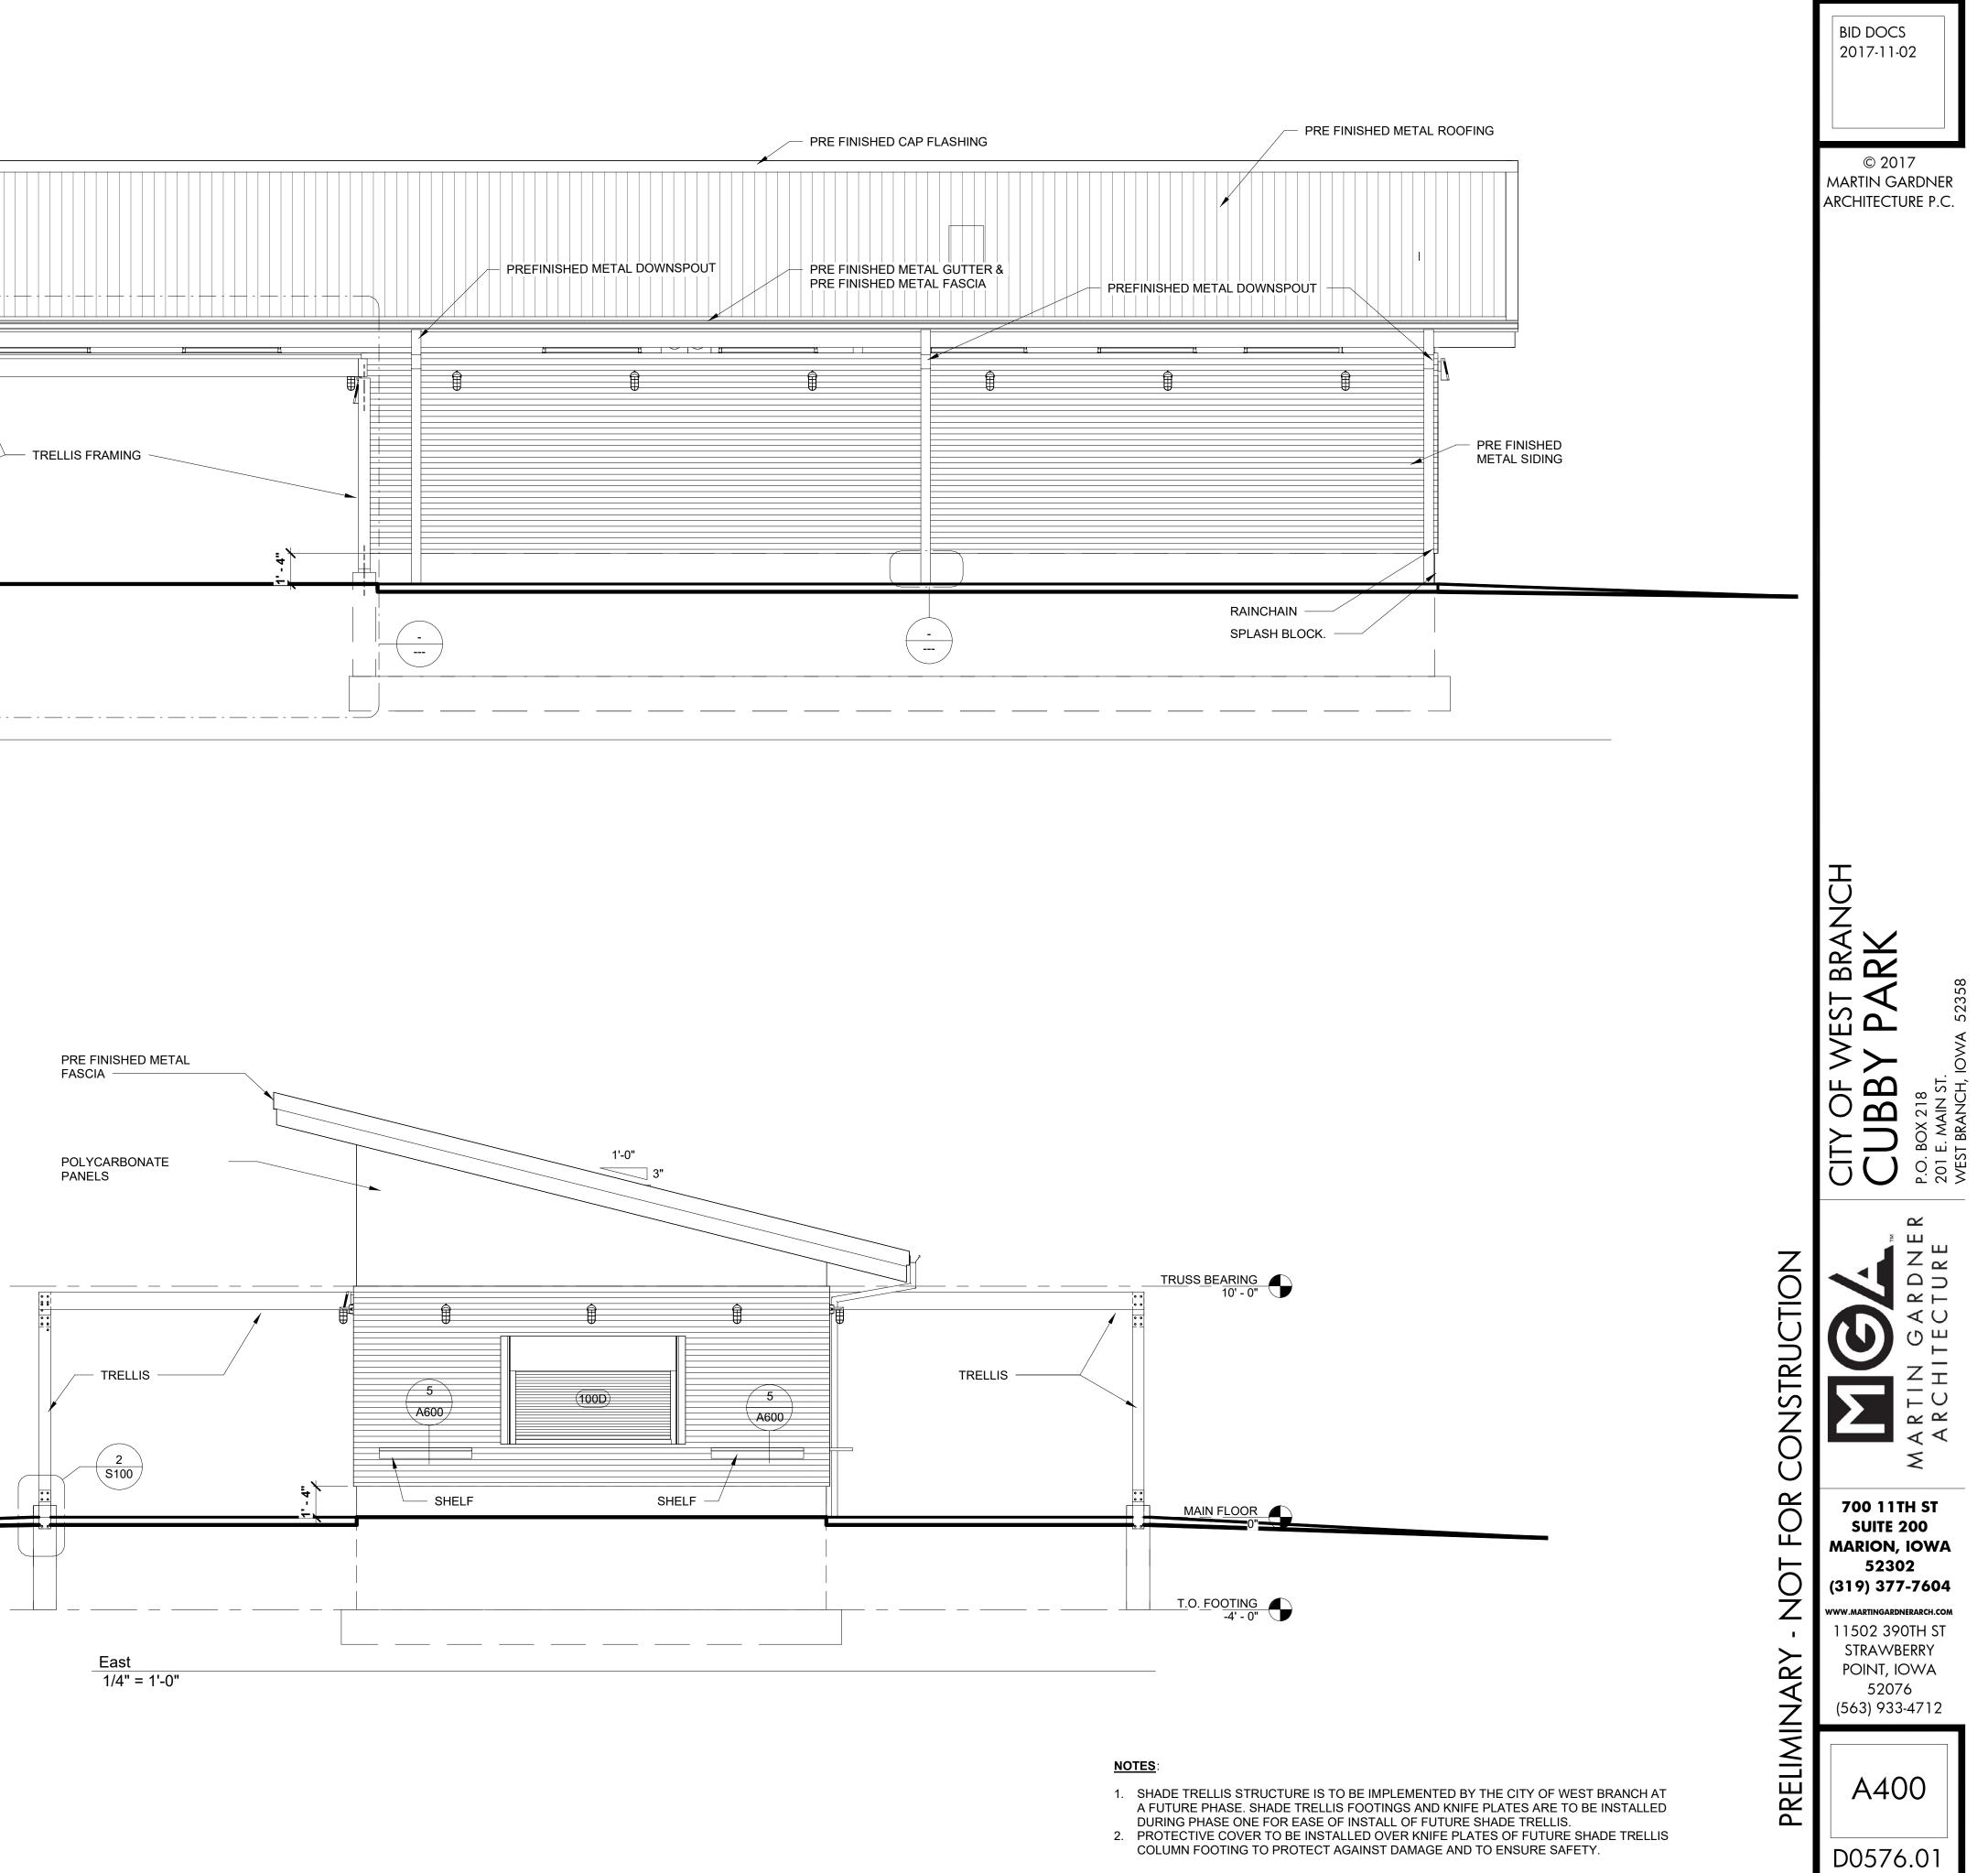




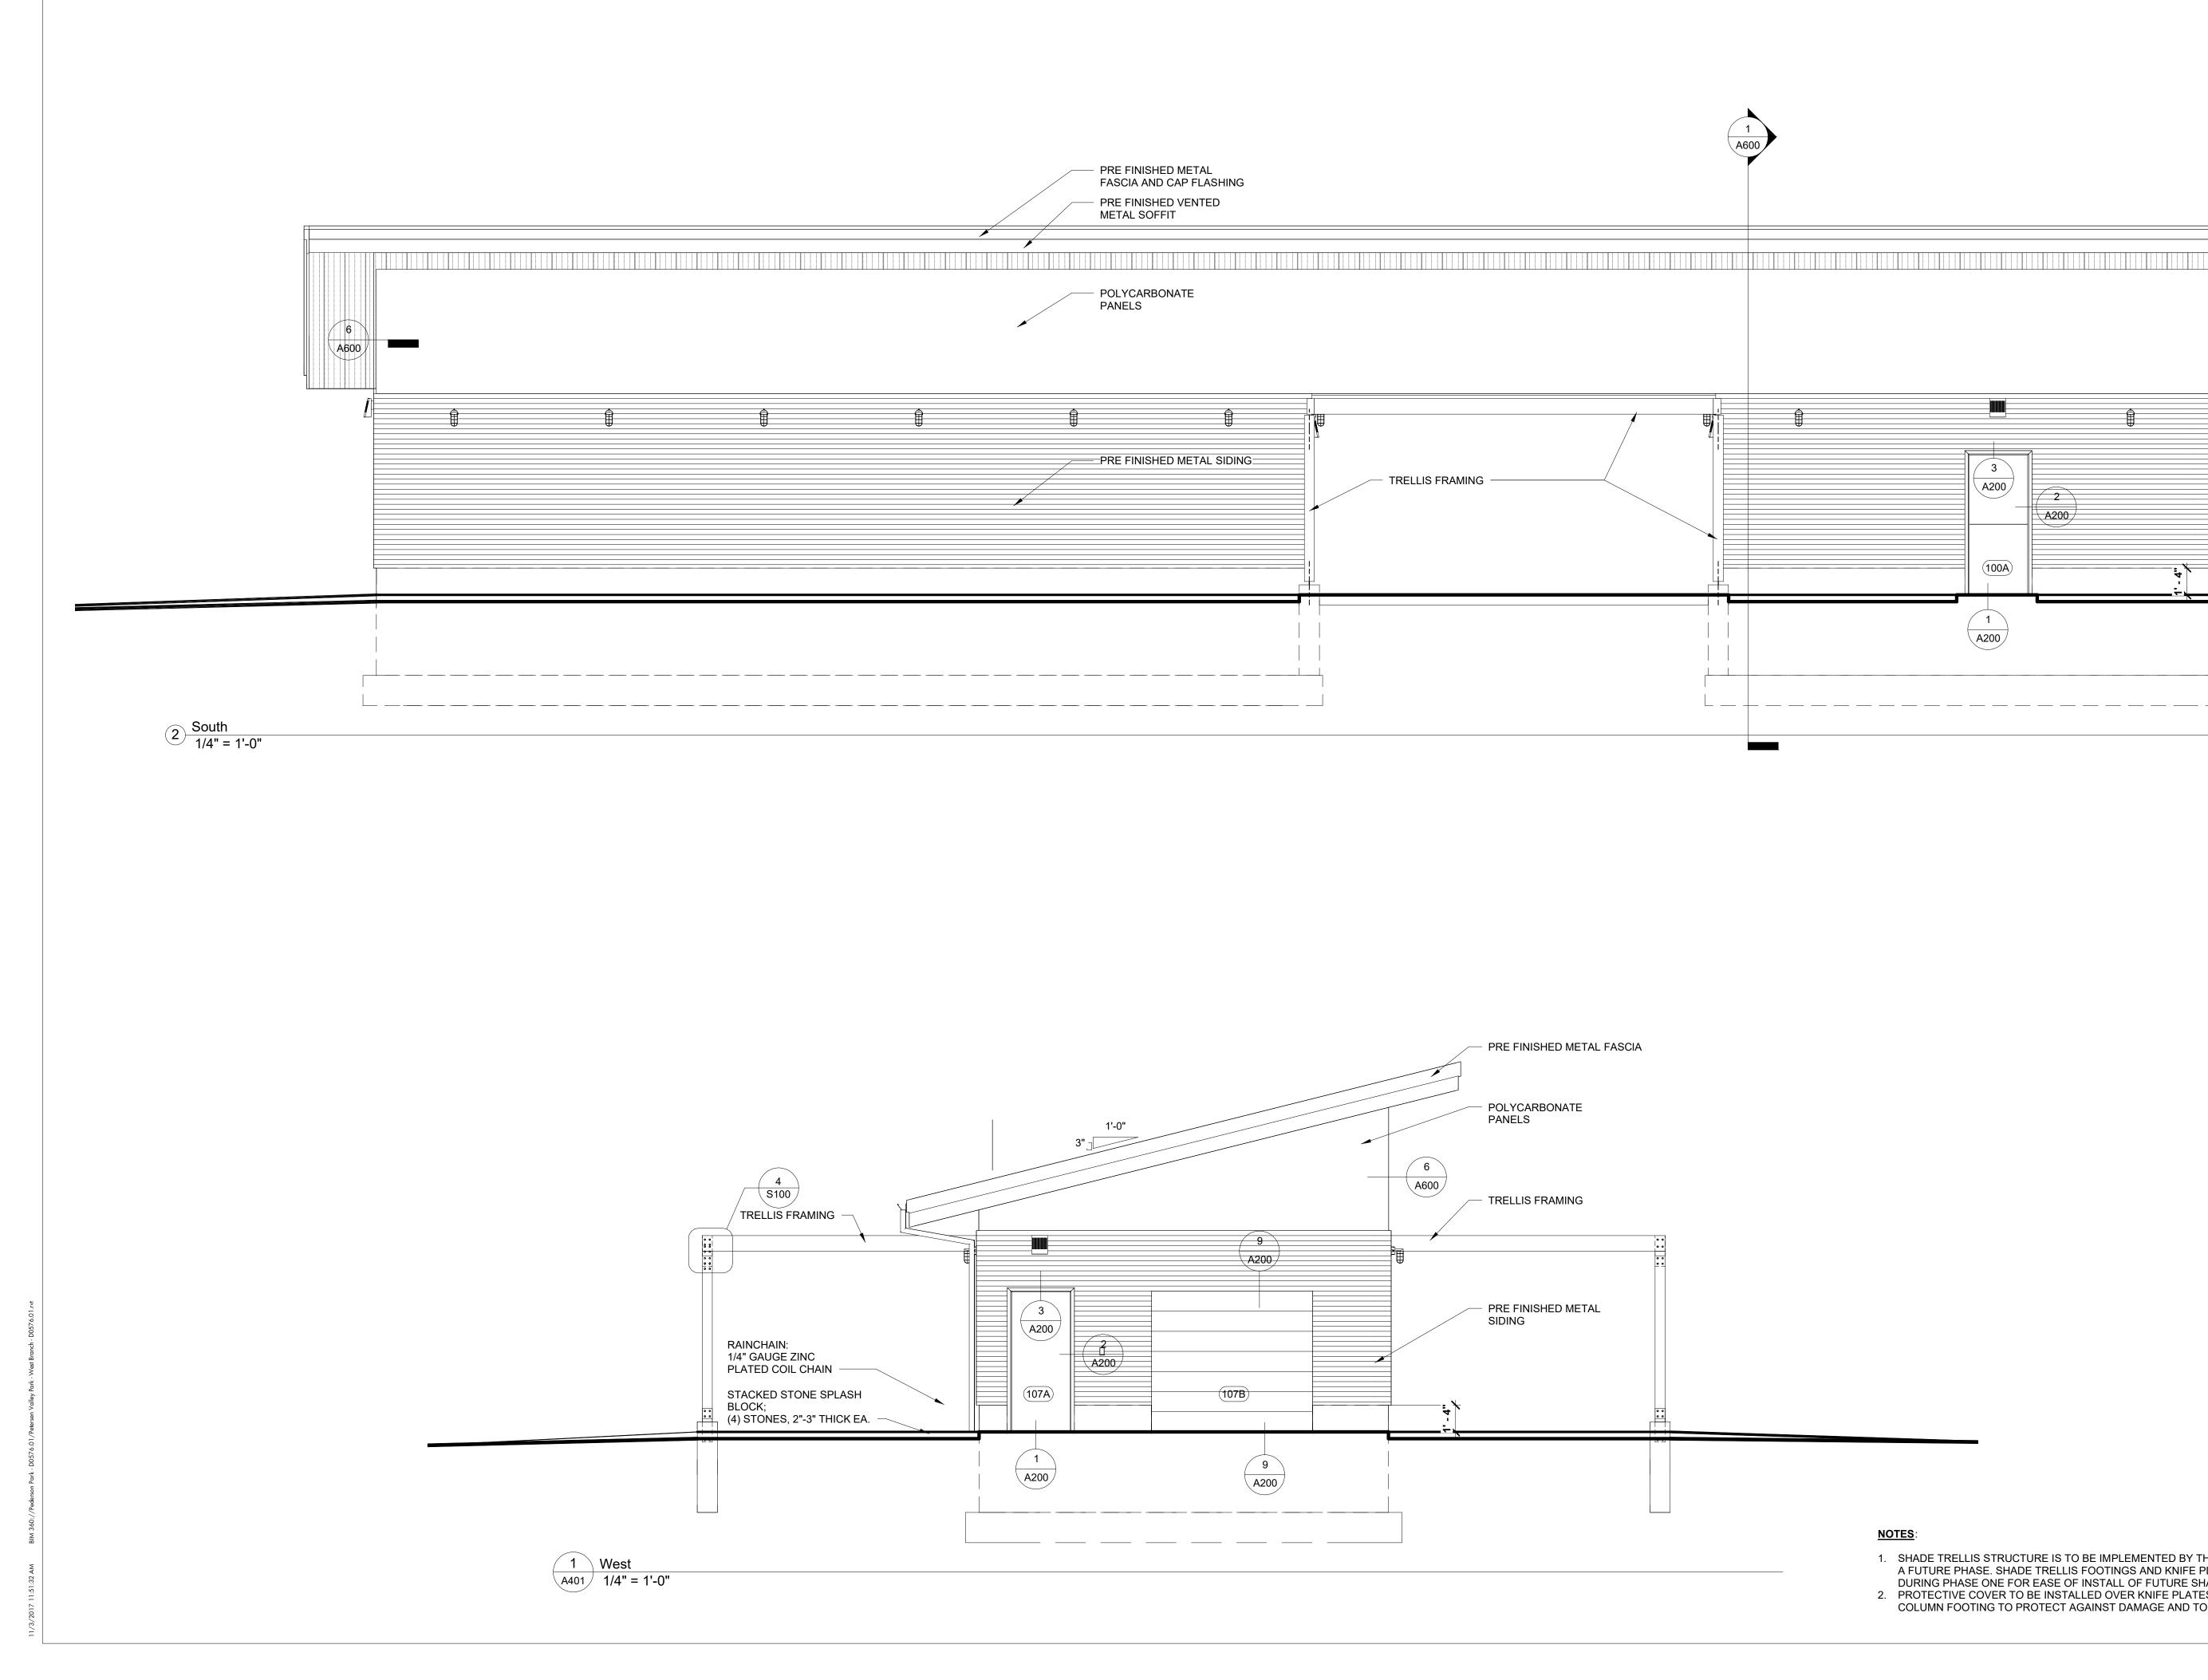


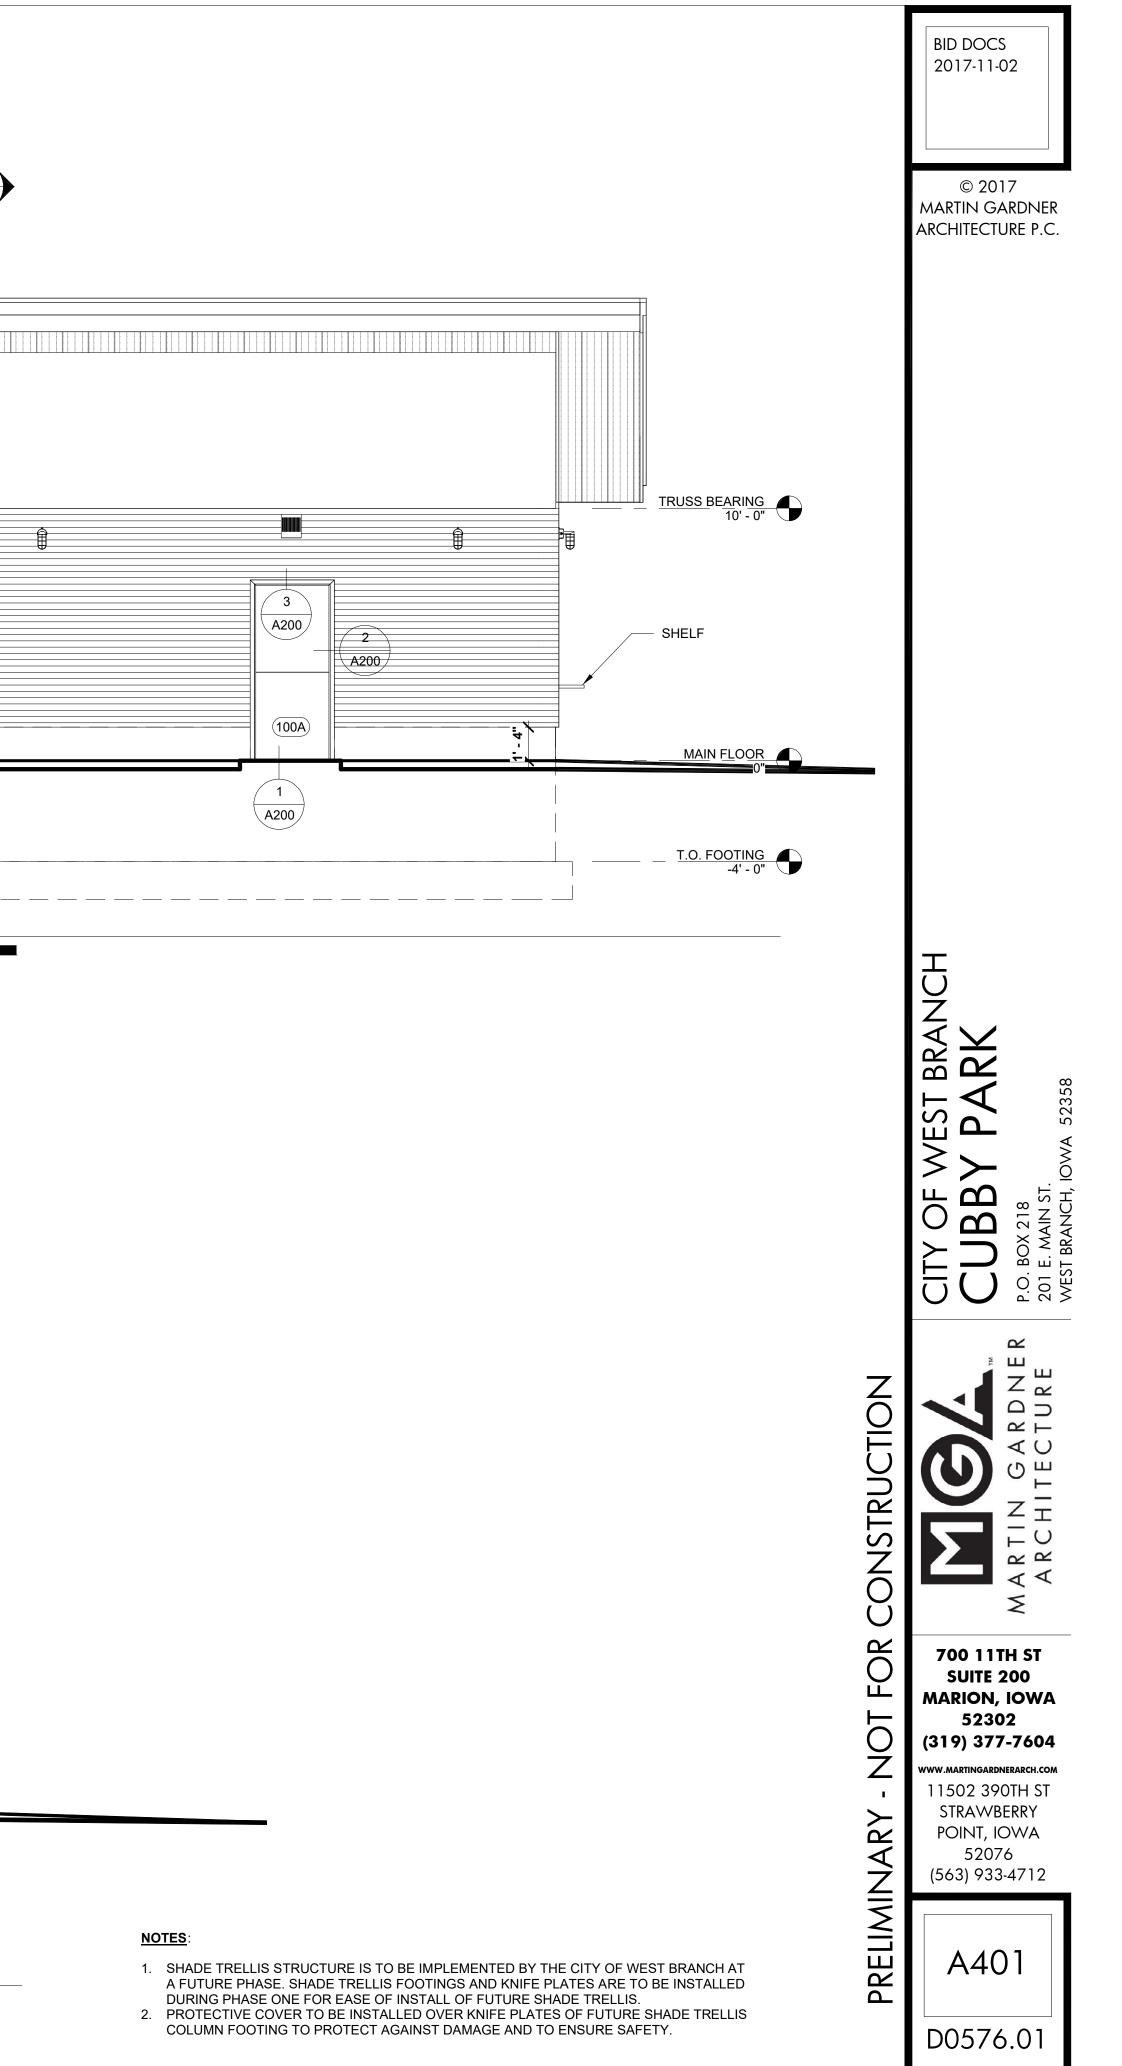

NOTES:


- 1. SHADE TRELLIS STRUCTURE IS TO BE IMPLEMENTED BY THE CITY OF WEST BRANCH AT

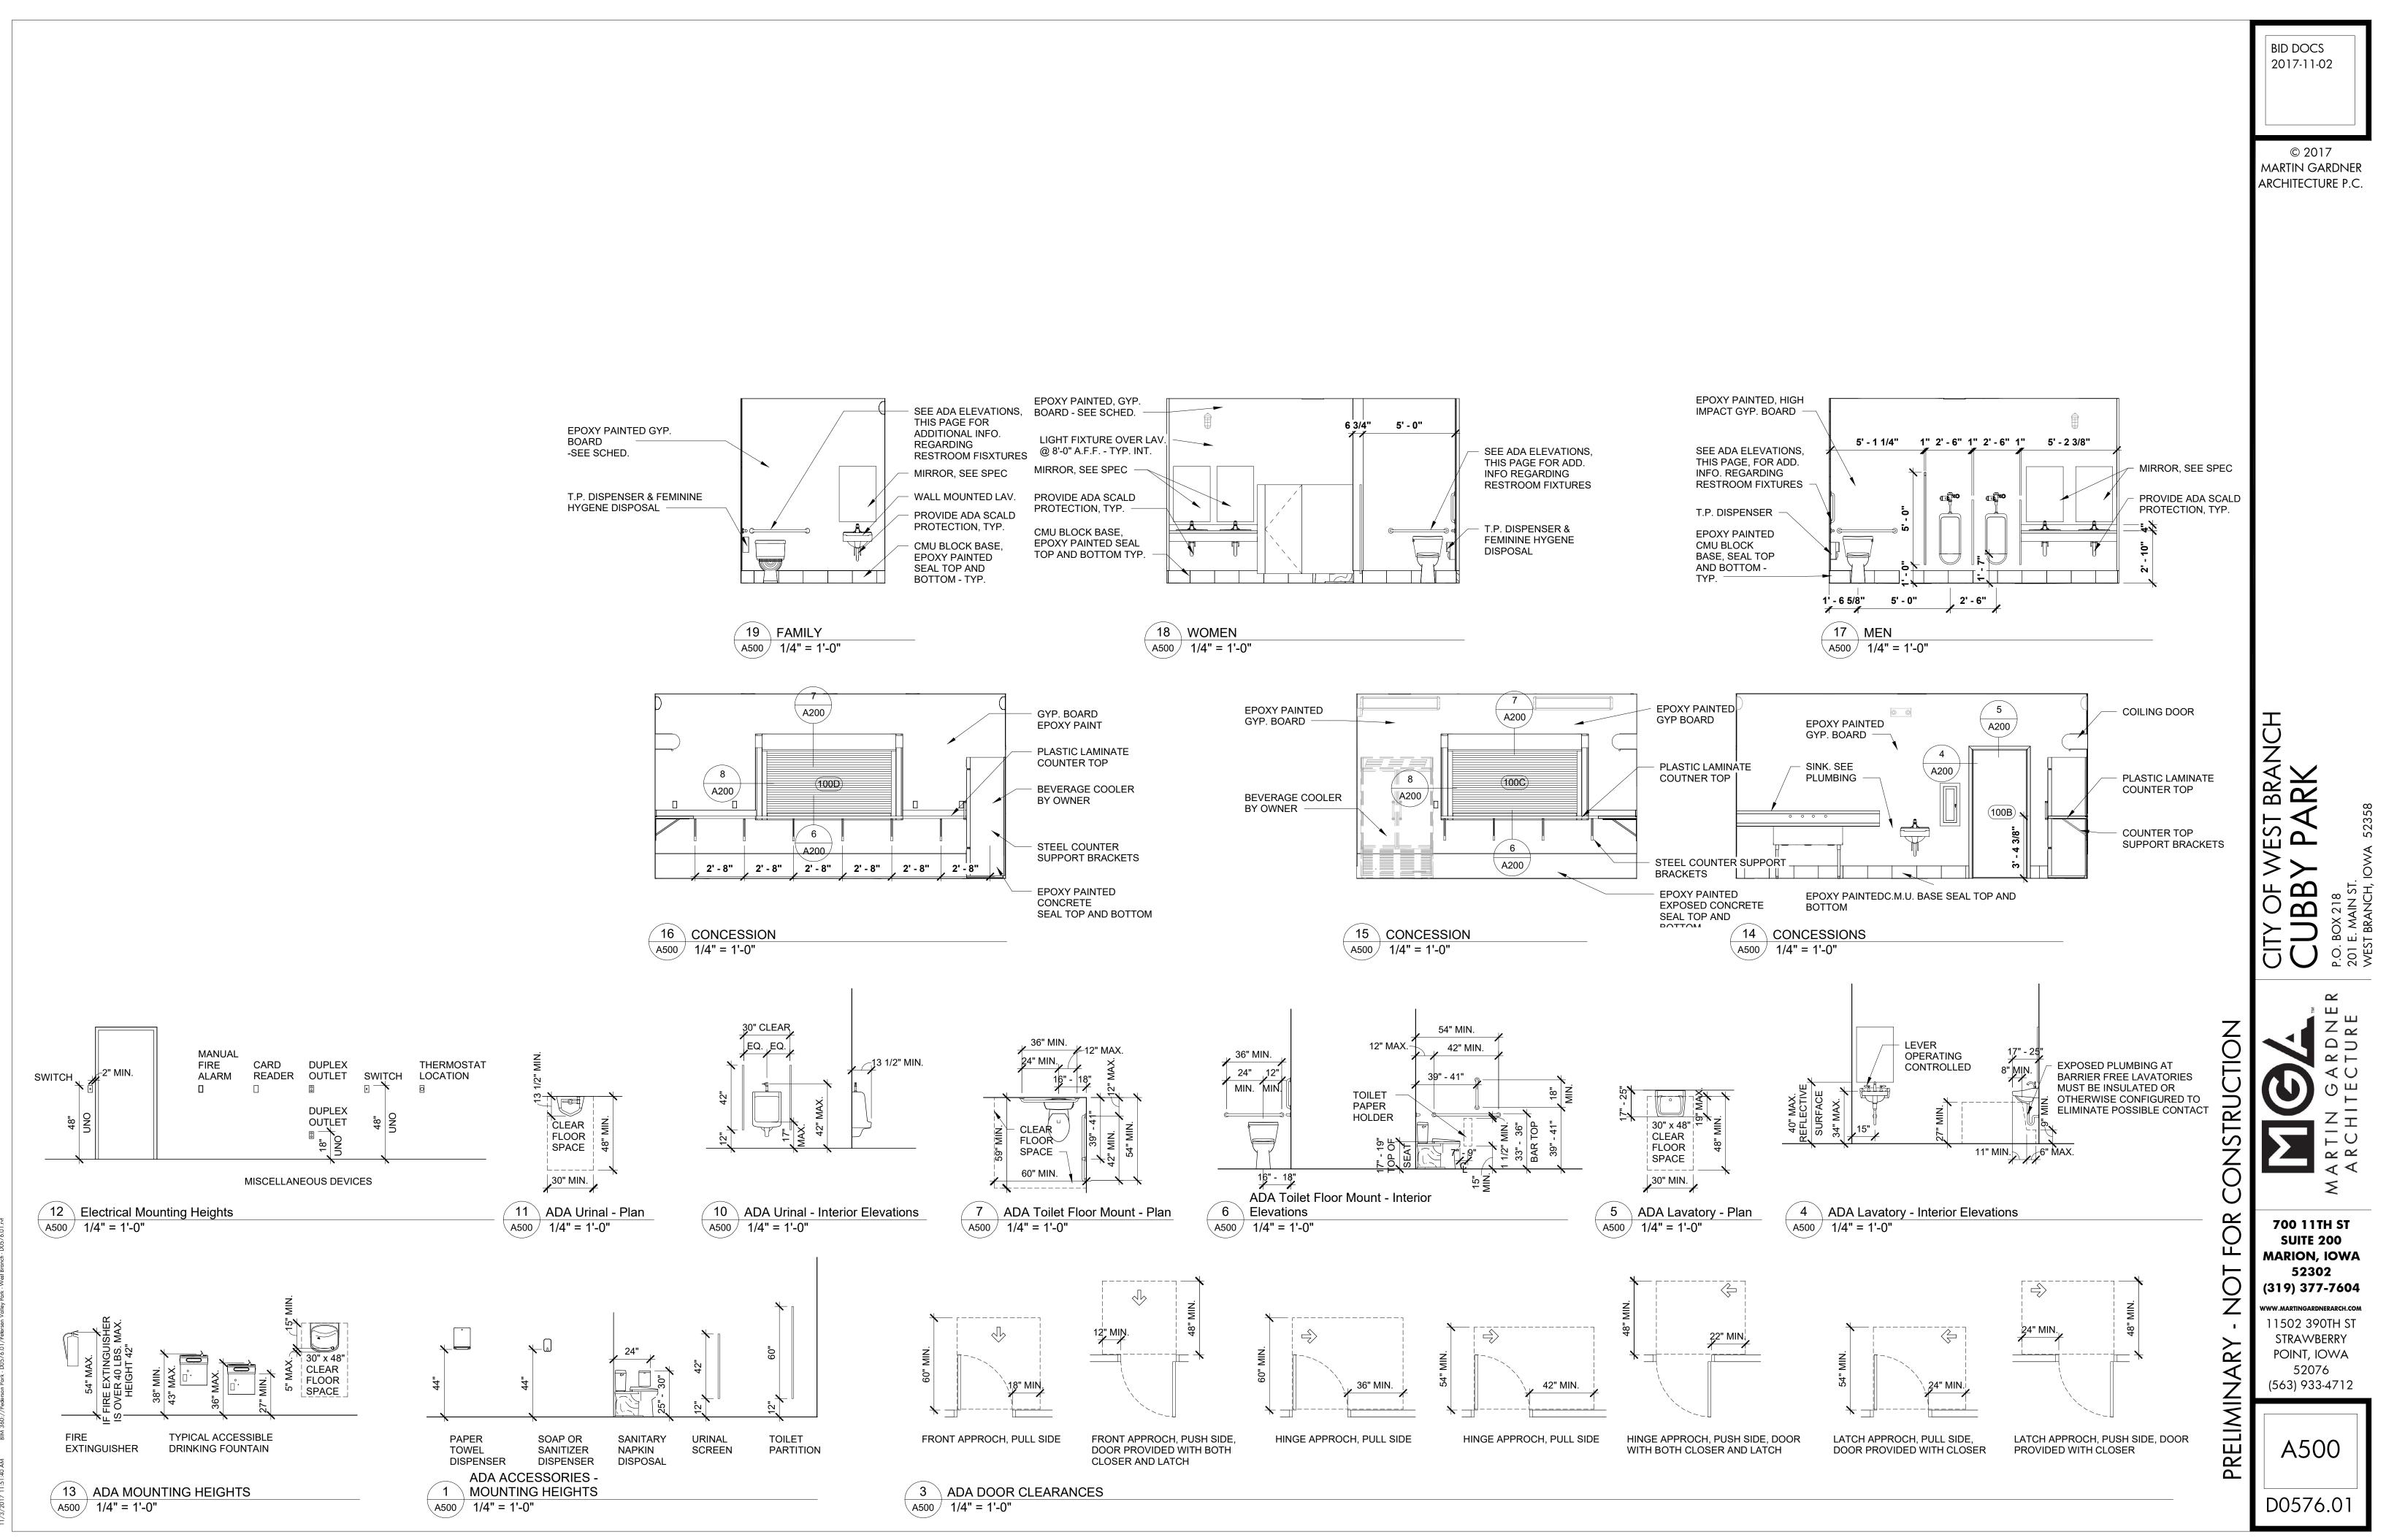

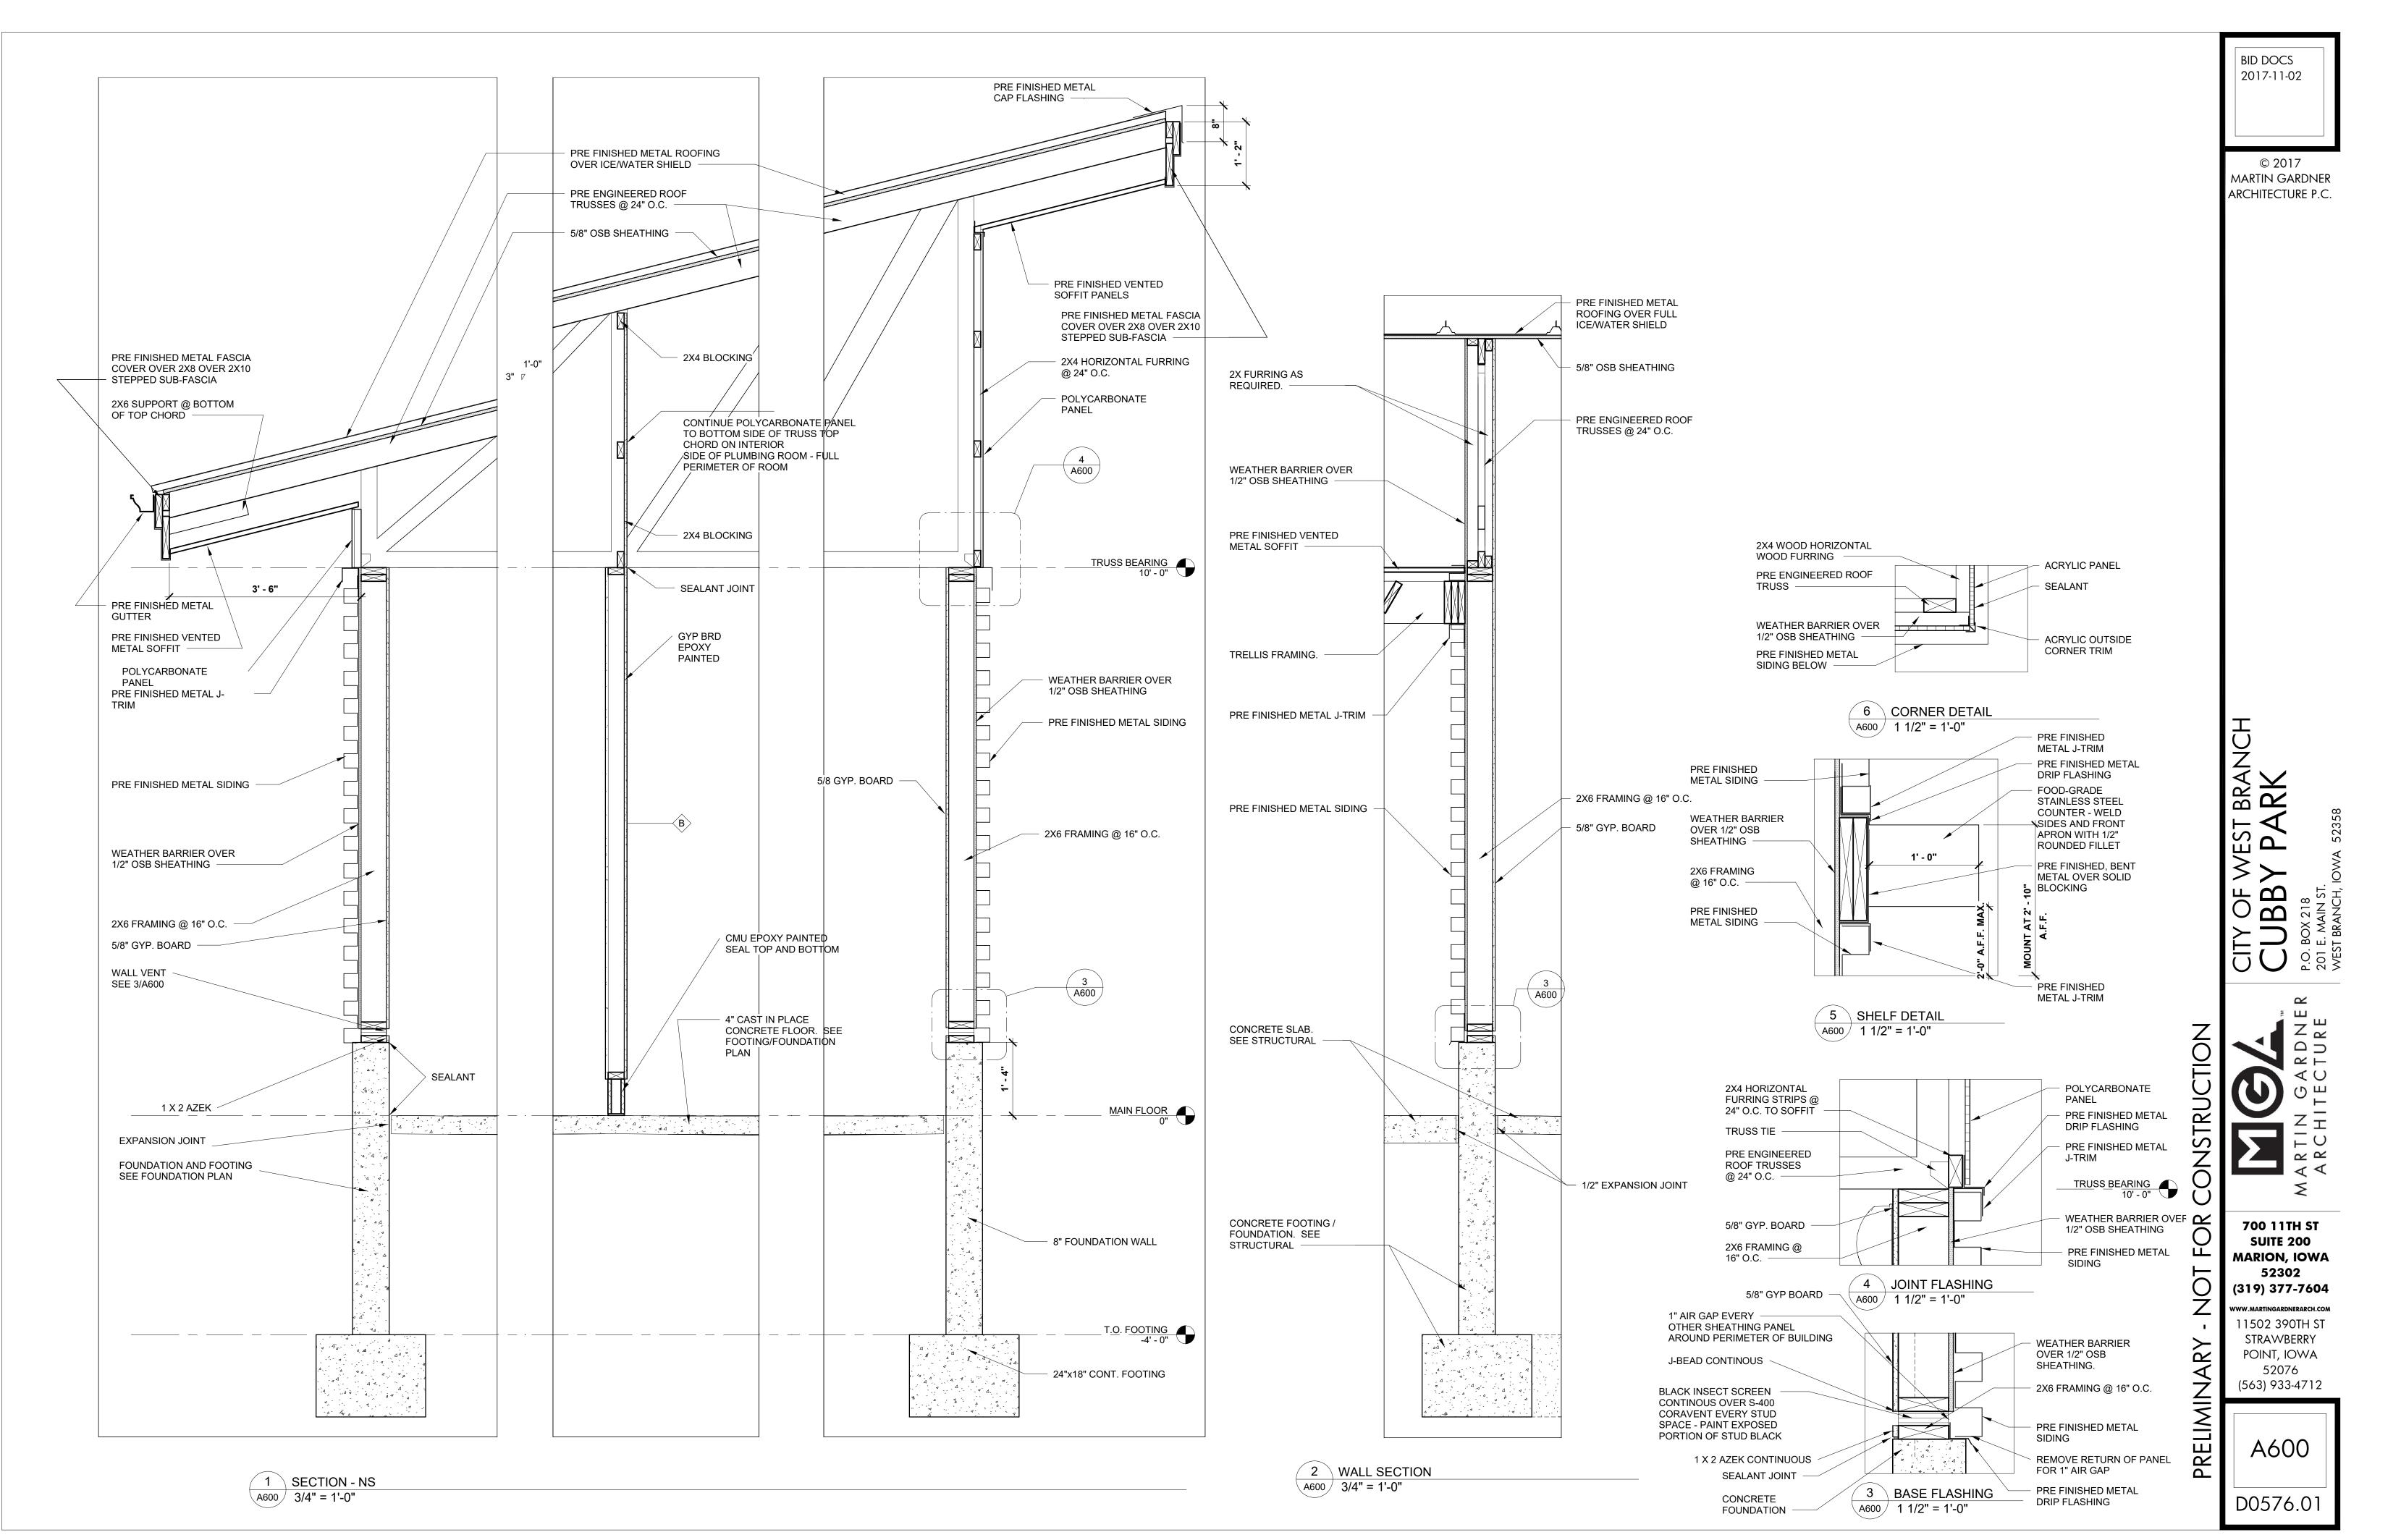


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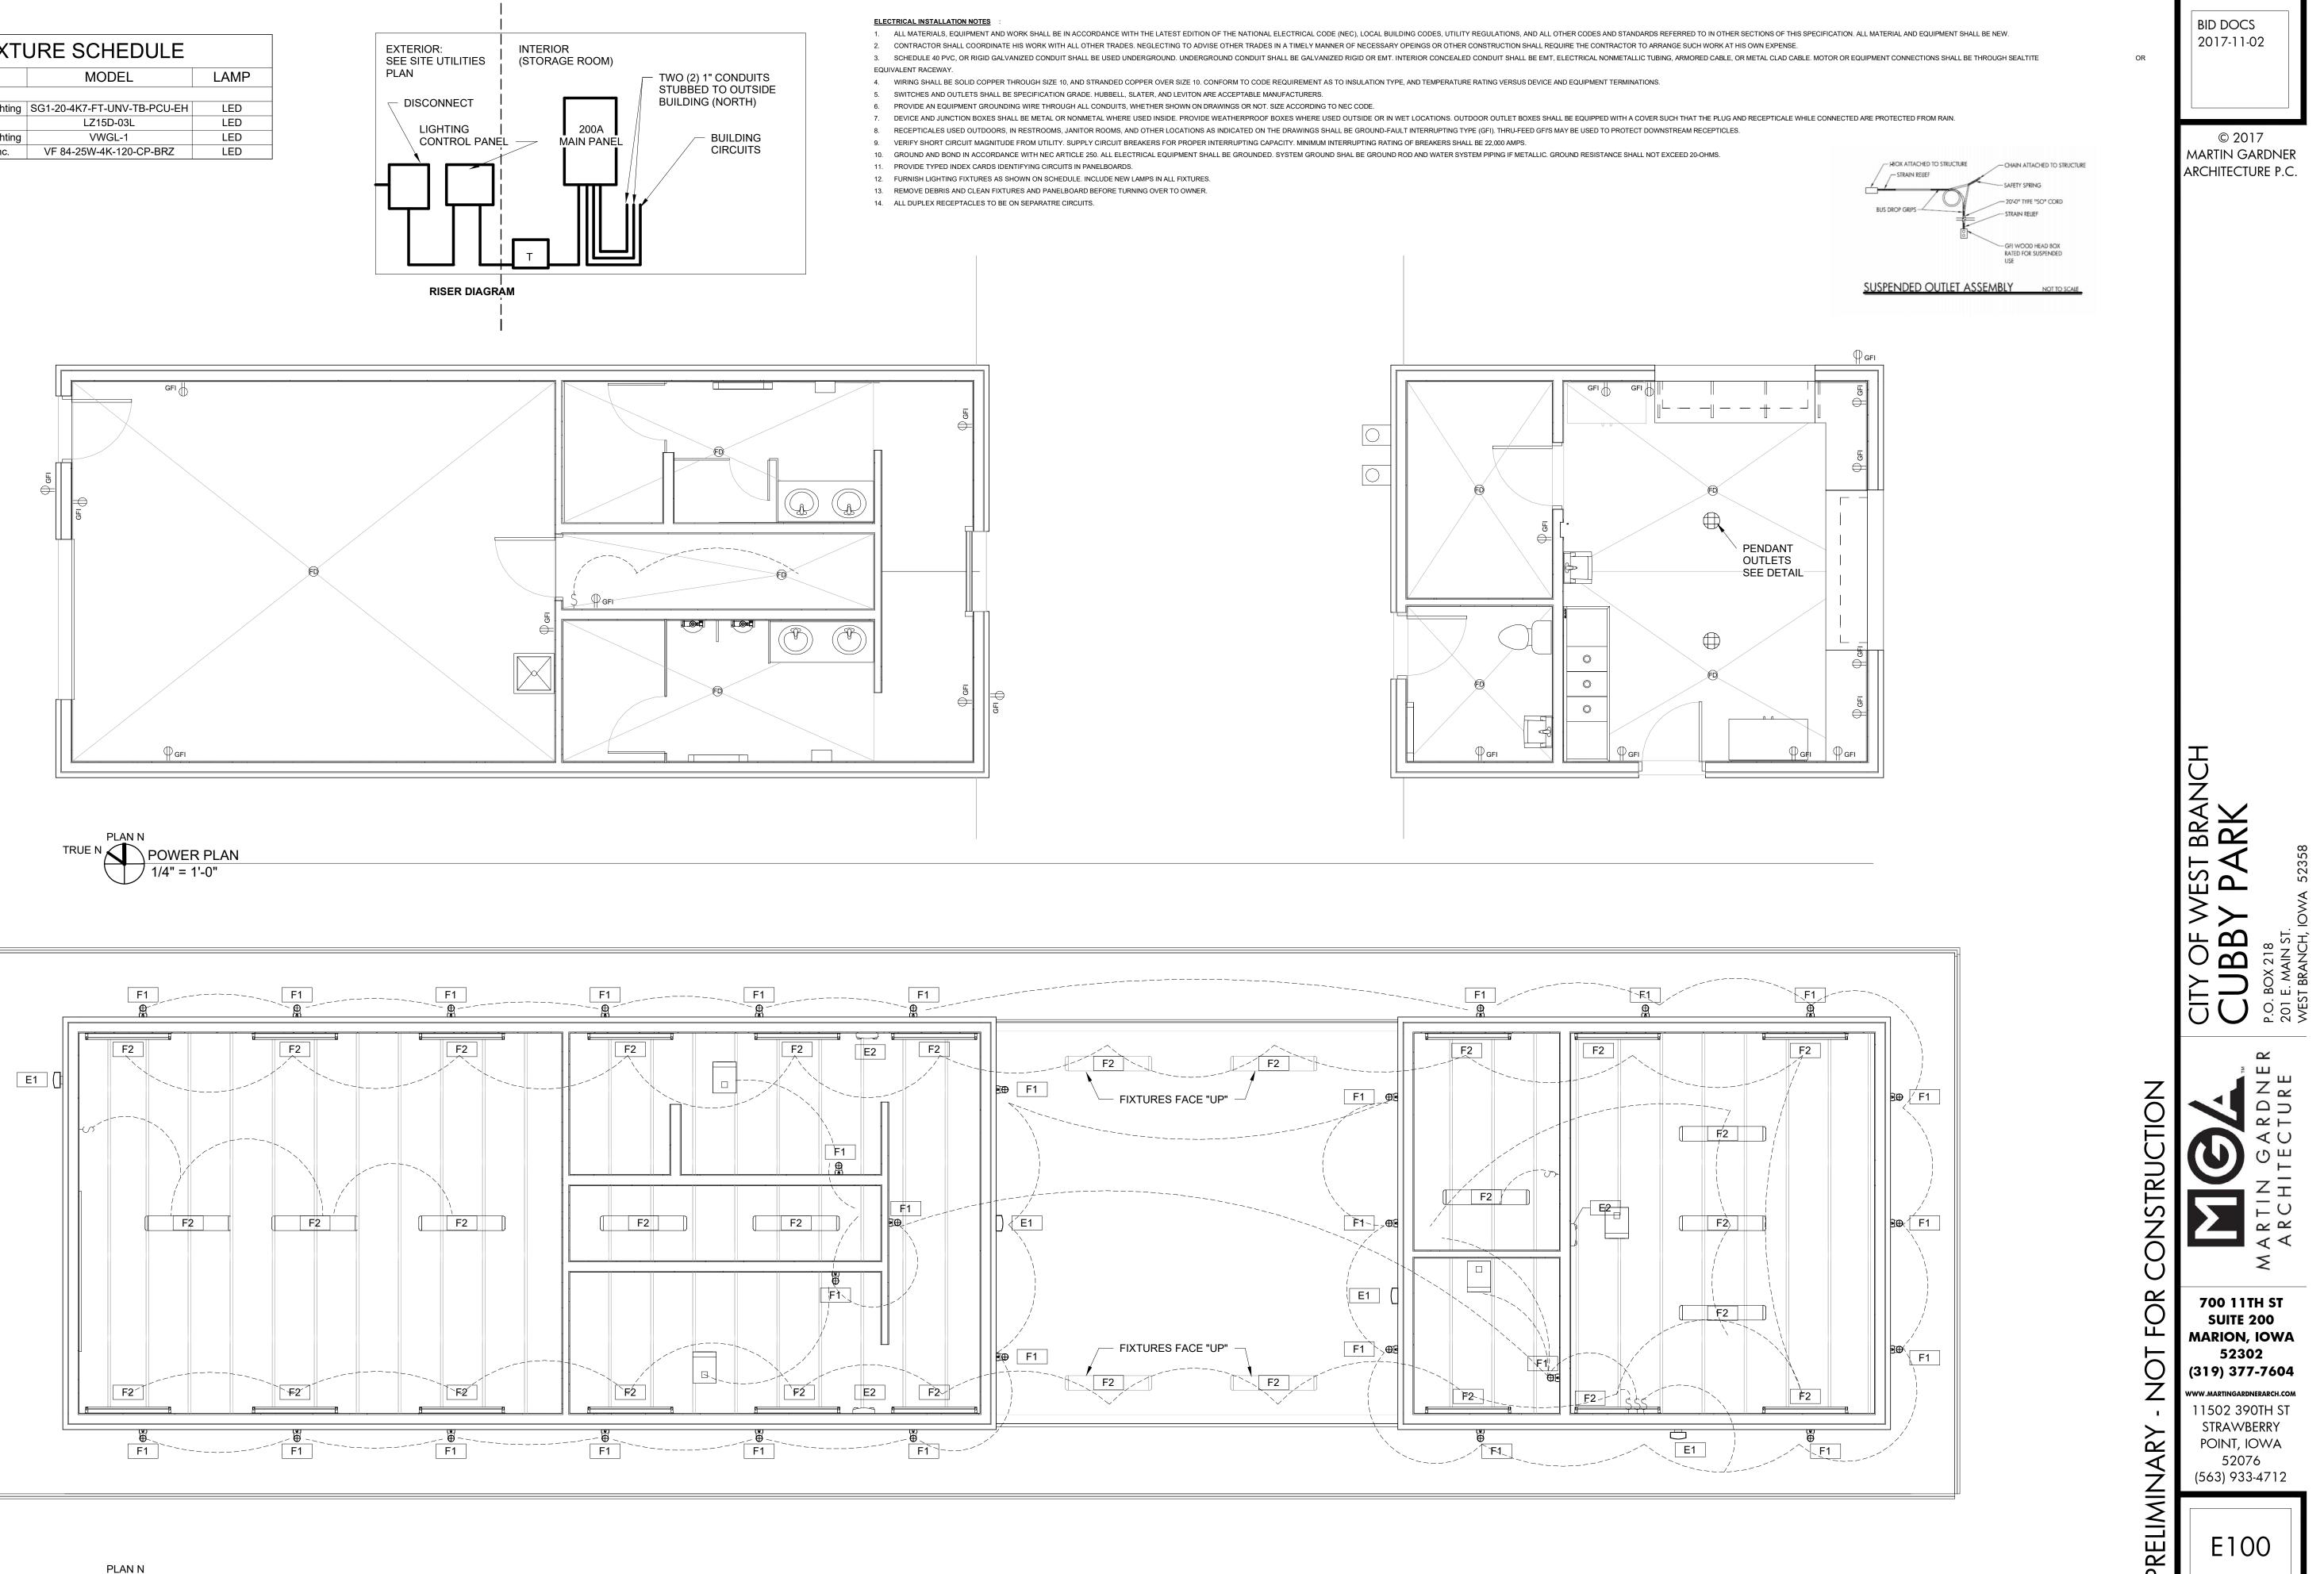
LIGHT FIXTURE SCHEDULE								
WT	MFG	MODEL	LAMP					
E1	Hubbell Outdoor Lighting	SG1-20-4K7-FT-UNV-TB-PCU-EH	LED					
E2	Dual-Lite	LZ15D-03L	LED					
F1	Hubbell Outdoor Lighting	VWGL-1	LED					
F2	Luminaire LED, Inc.	VF 84-25W-4K-120-CP-BRZ	LED					

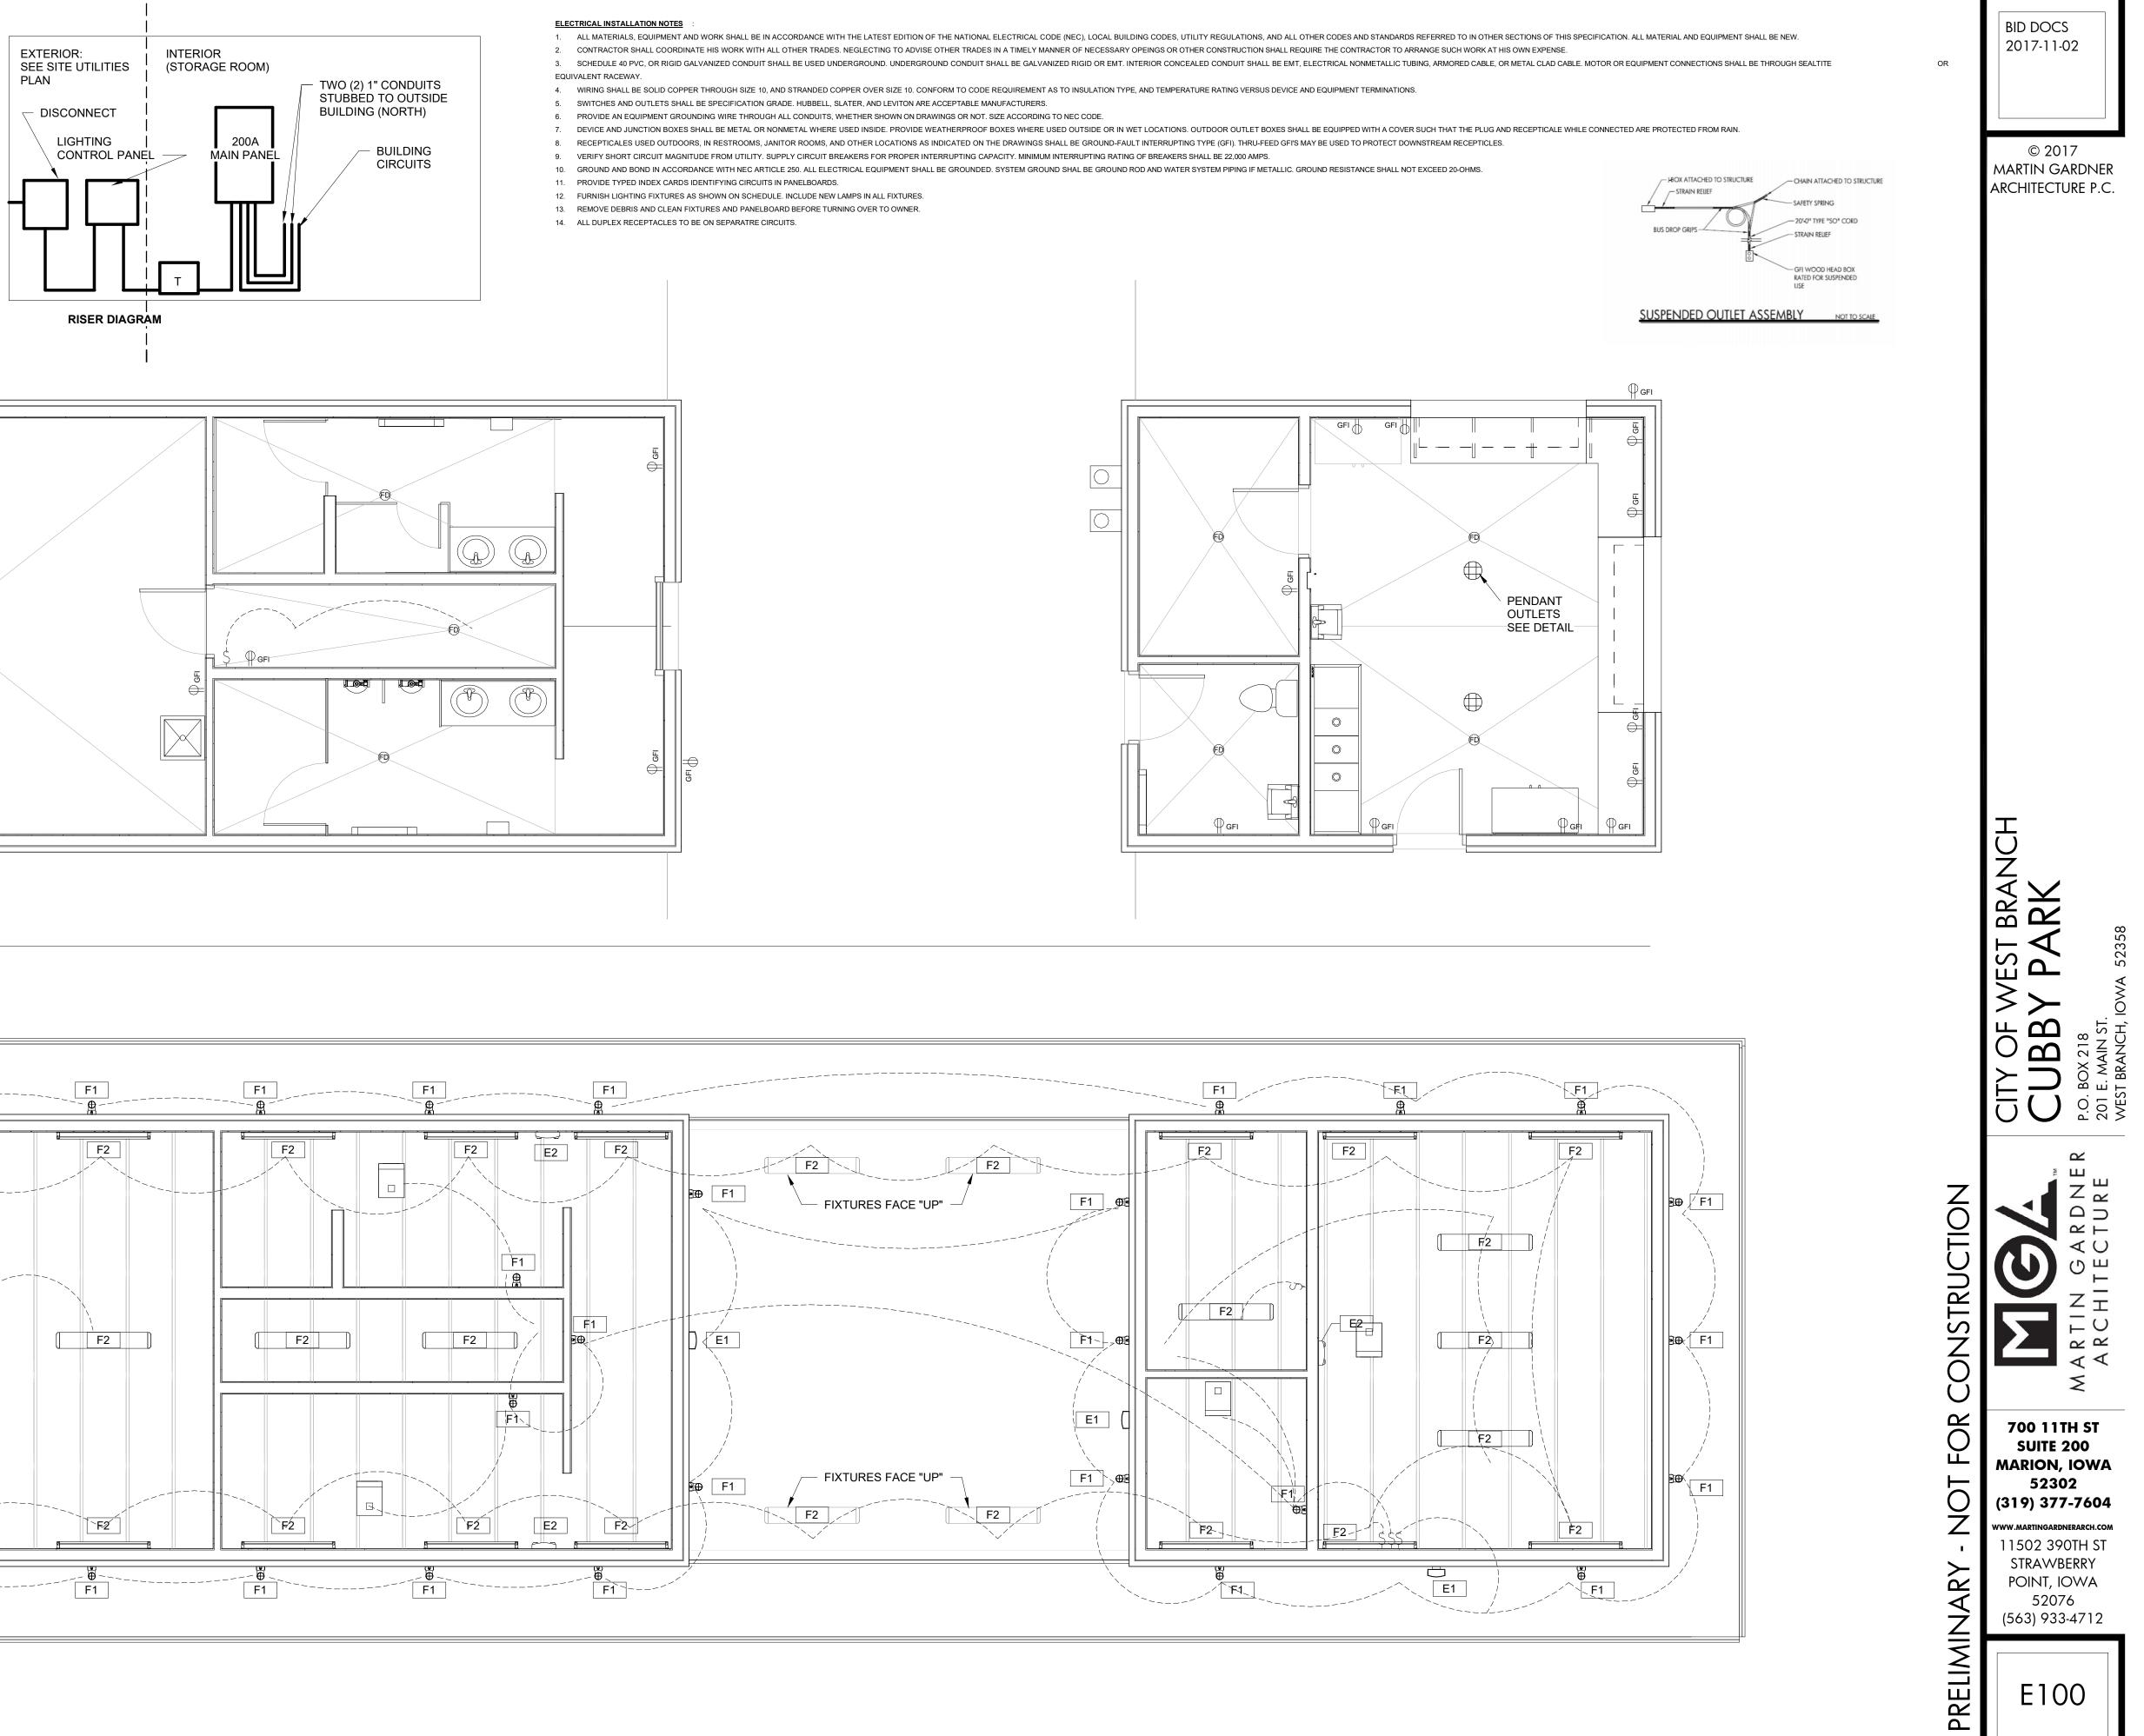



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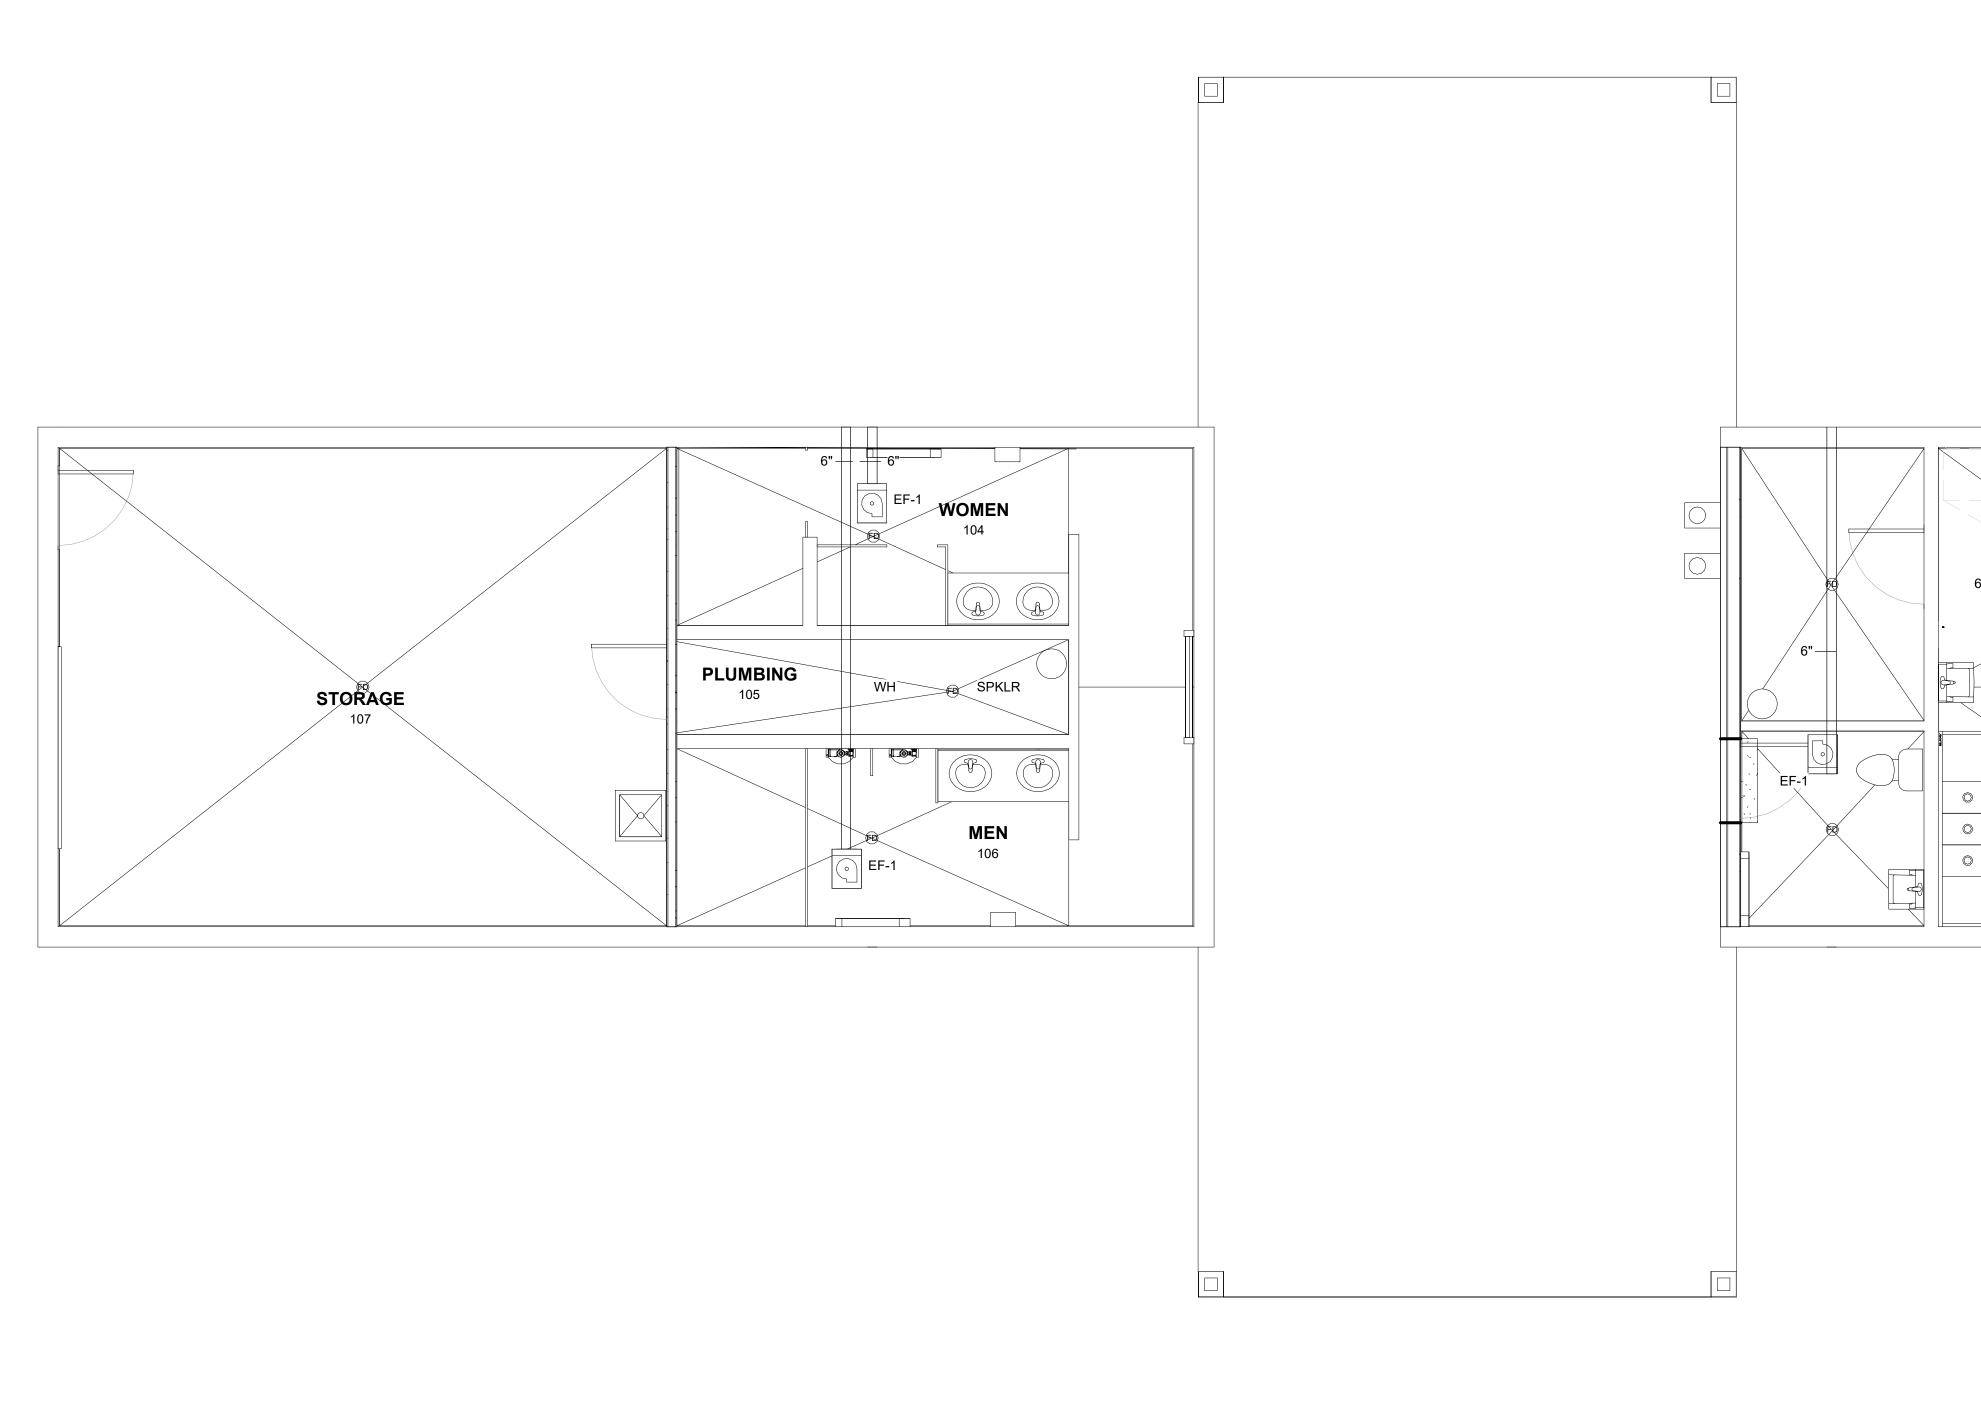





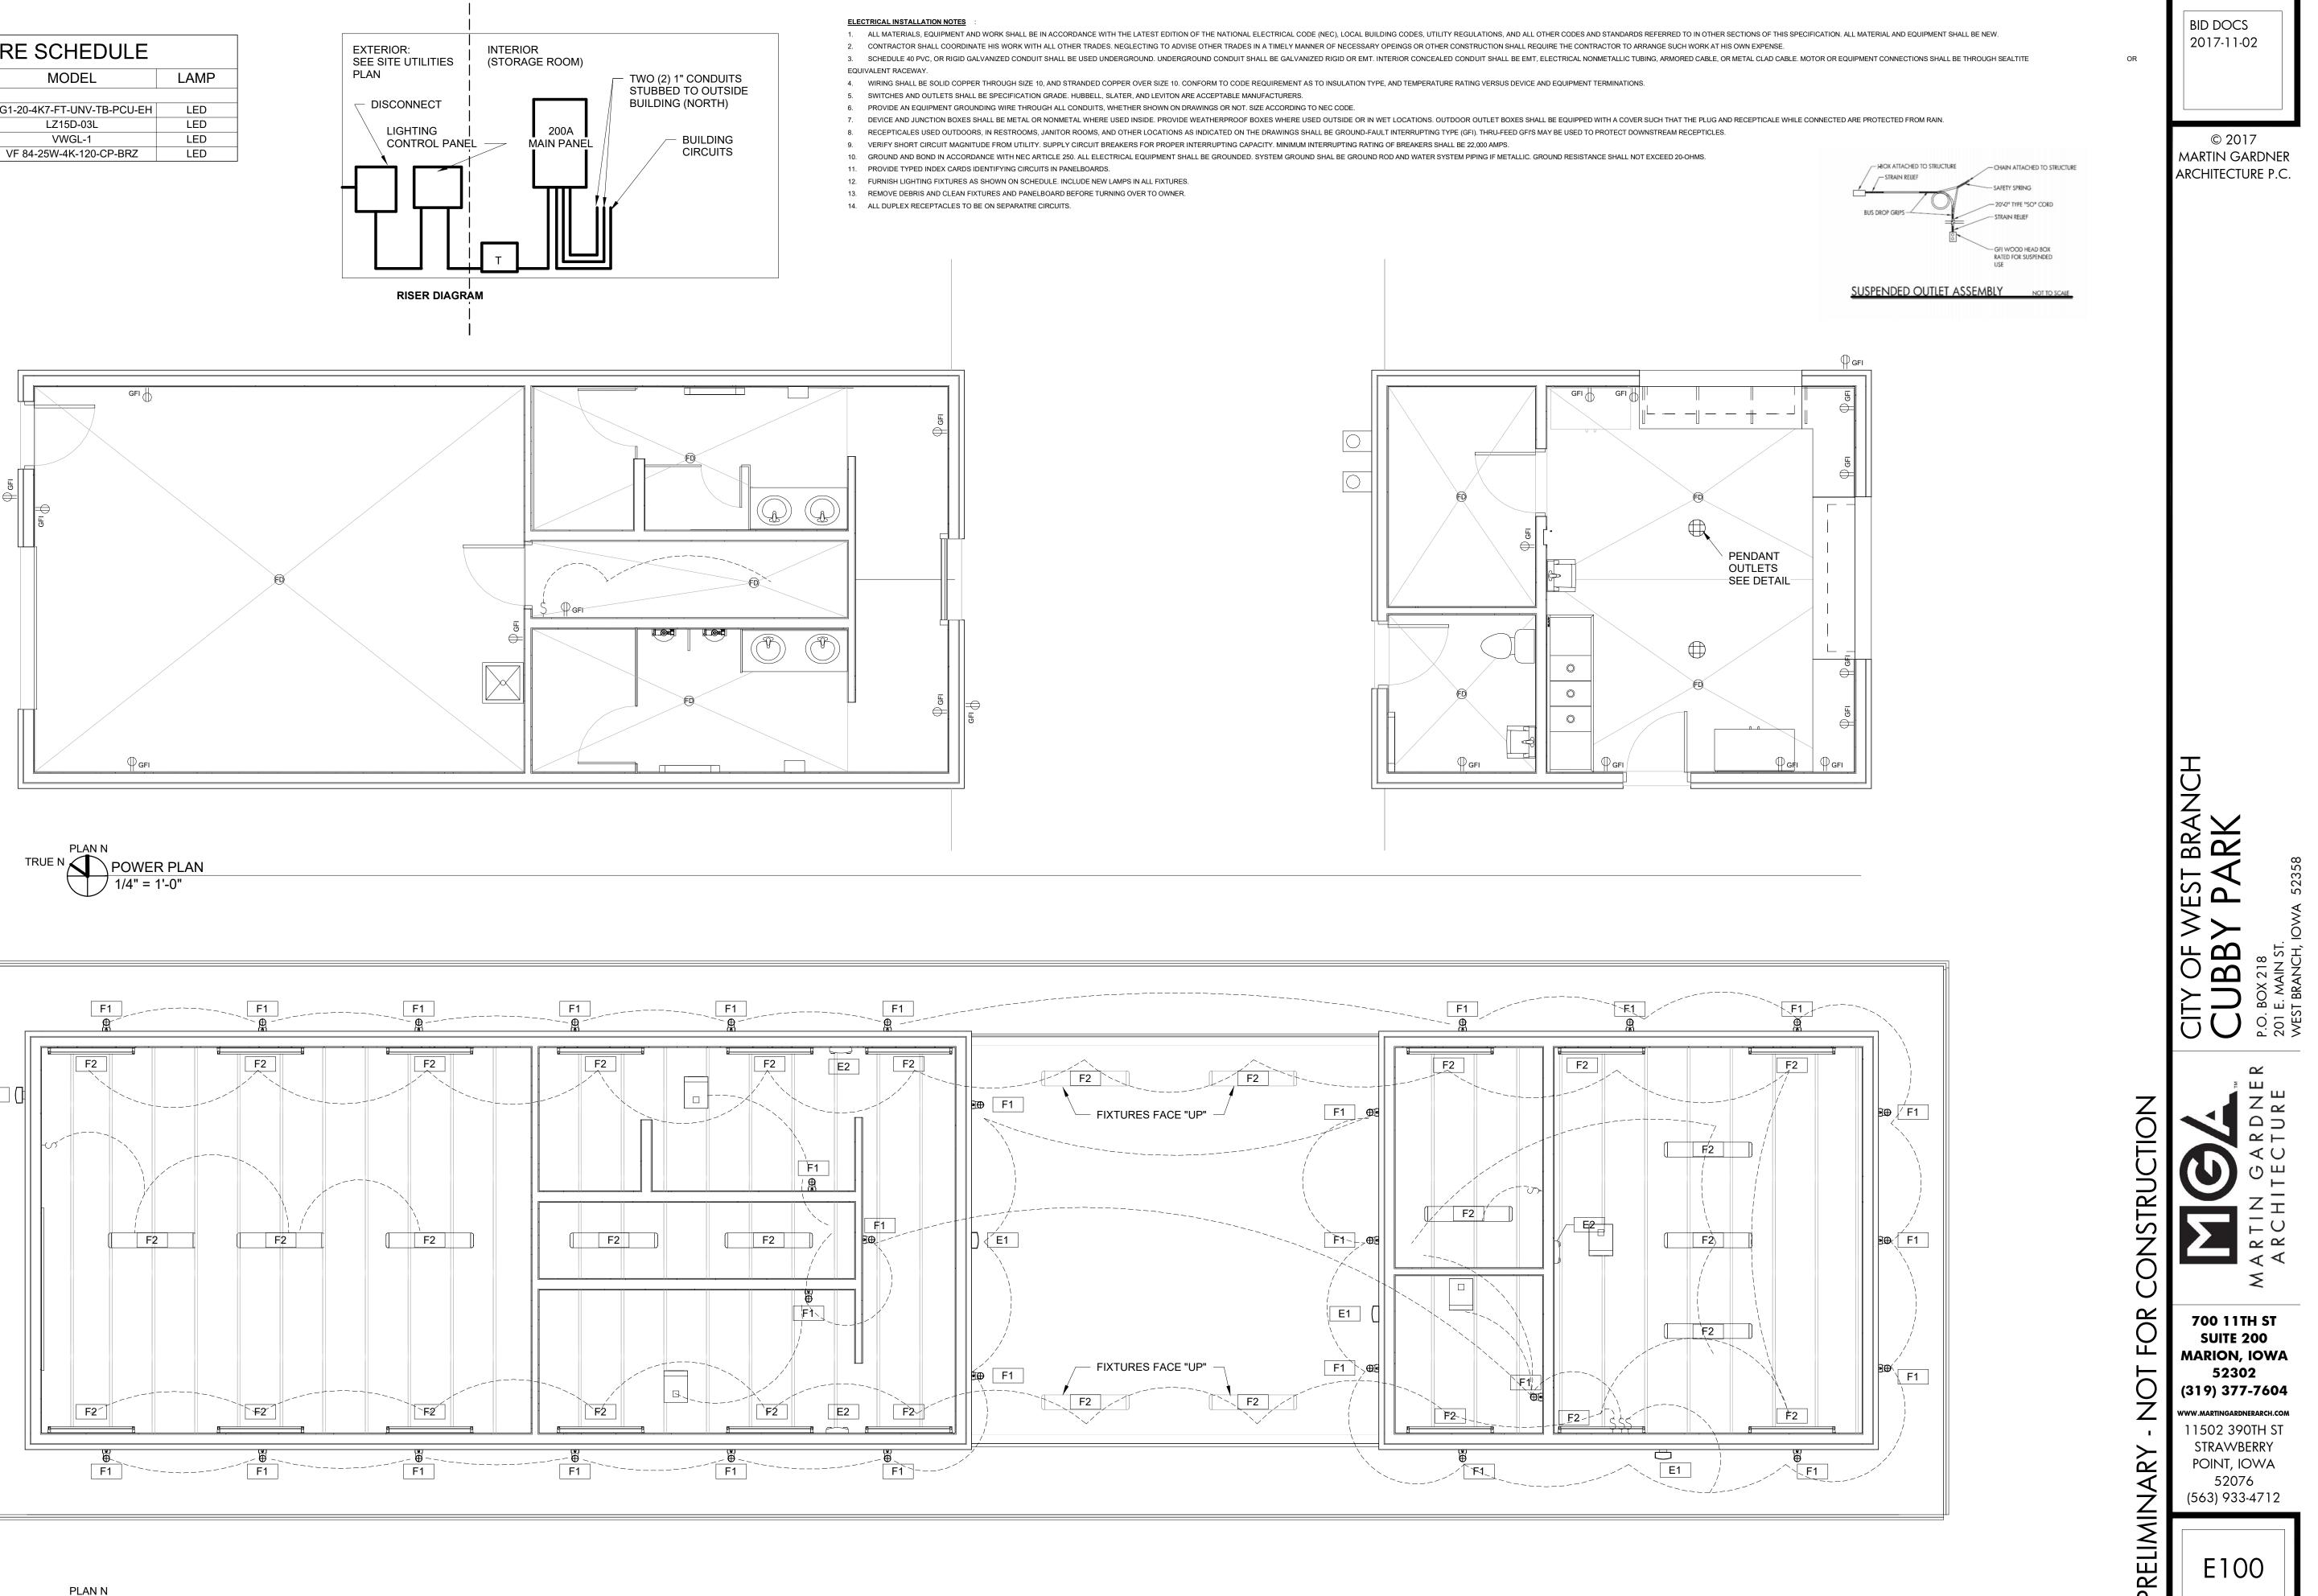

1.	TOTA	AL SQUARE F	OOTAGE: 343.50 SF			
2. ALL LANDSCAPED AREA SURROUNDING BUILDING AS SHOWN TO BE DENSLEY SEEDED WITH SEED						
	-	QTY 1:	MESIC WILDFLOWER MIX	LATIN NAME: NA	SKU# 162	
	-	QTY: 2oz	BIRD AND BUTTERFLY FLOWER MIX	LATIN NAME: NA	SKU# 013	
	-	QTY: 1M	PRAIRE, BIG BLUESTEM	LATIN NAME: ANDROPOGON GERARDII	SKU# 09	
3.	GRU	B AND REMC	VE EXISTING VEGETATION FROM TOPSOI	L. STORE TOPSOIL & REPLACE AS BACKFILL F	OR A MINIMUN	
4.	INST	ALLATION TO	FOLLOW RECOMMENDATIONS OF SEED	SAVERS EXCHANGE. SOW SEED MIX 1-2 WEE	<s before="" la<="" td=""></s>	
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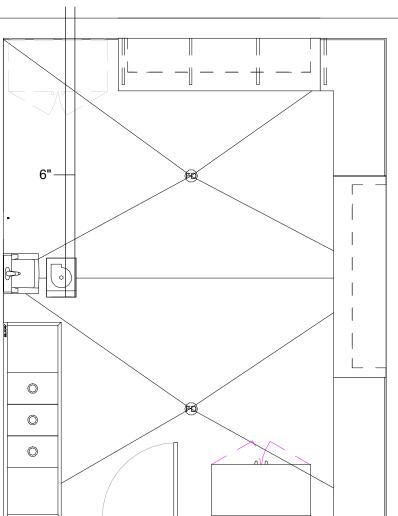


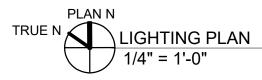MECHANICAL NOTES:

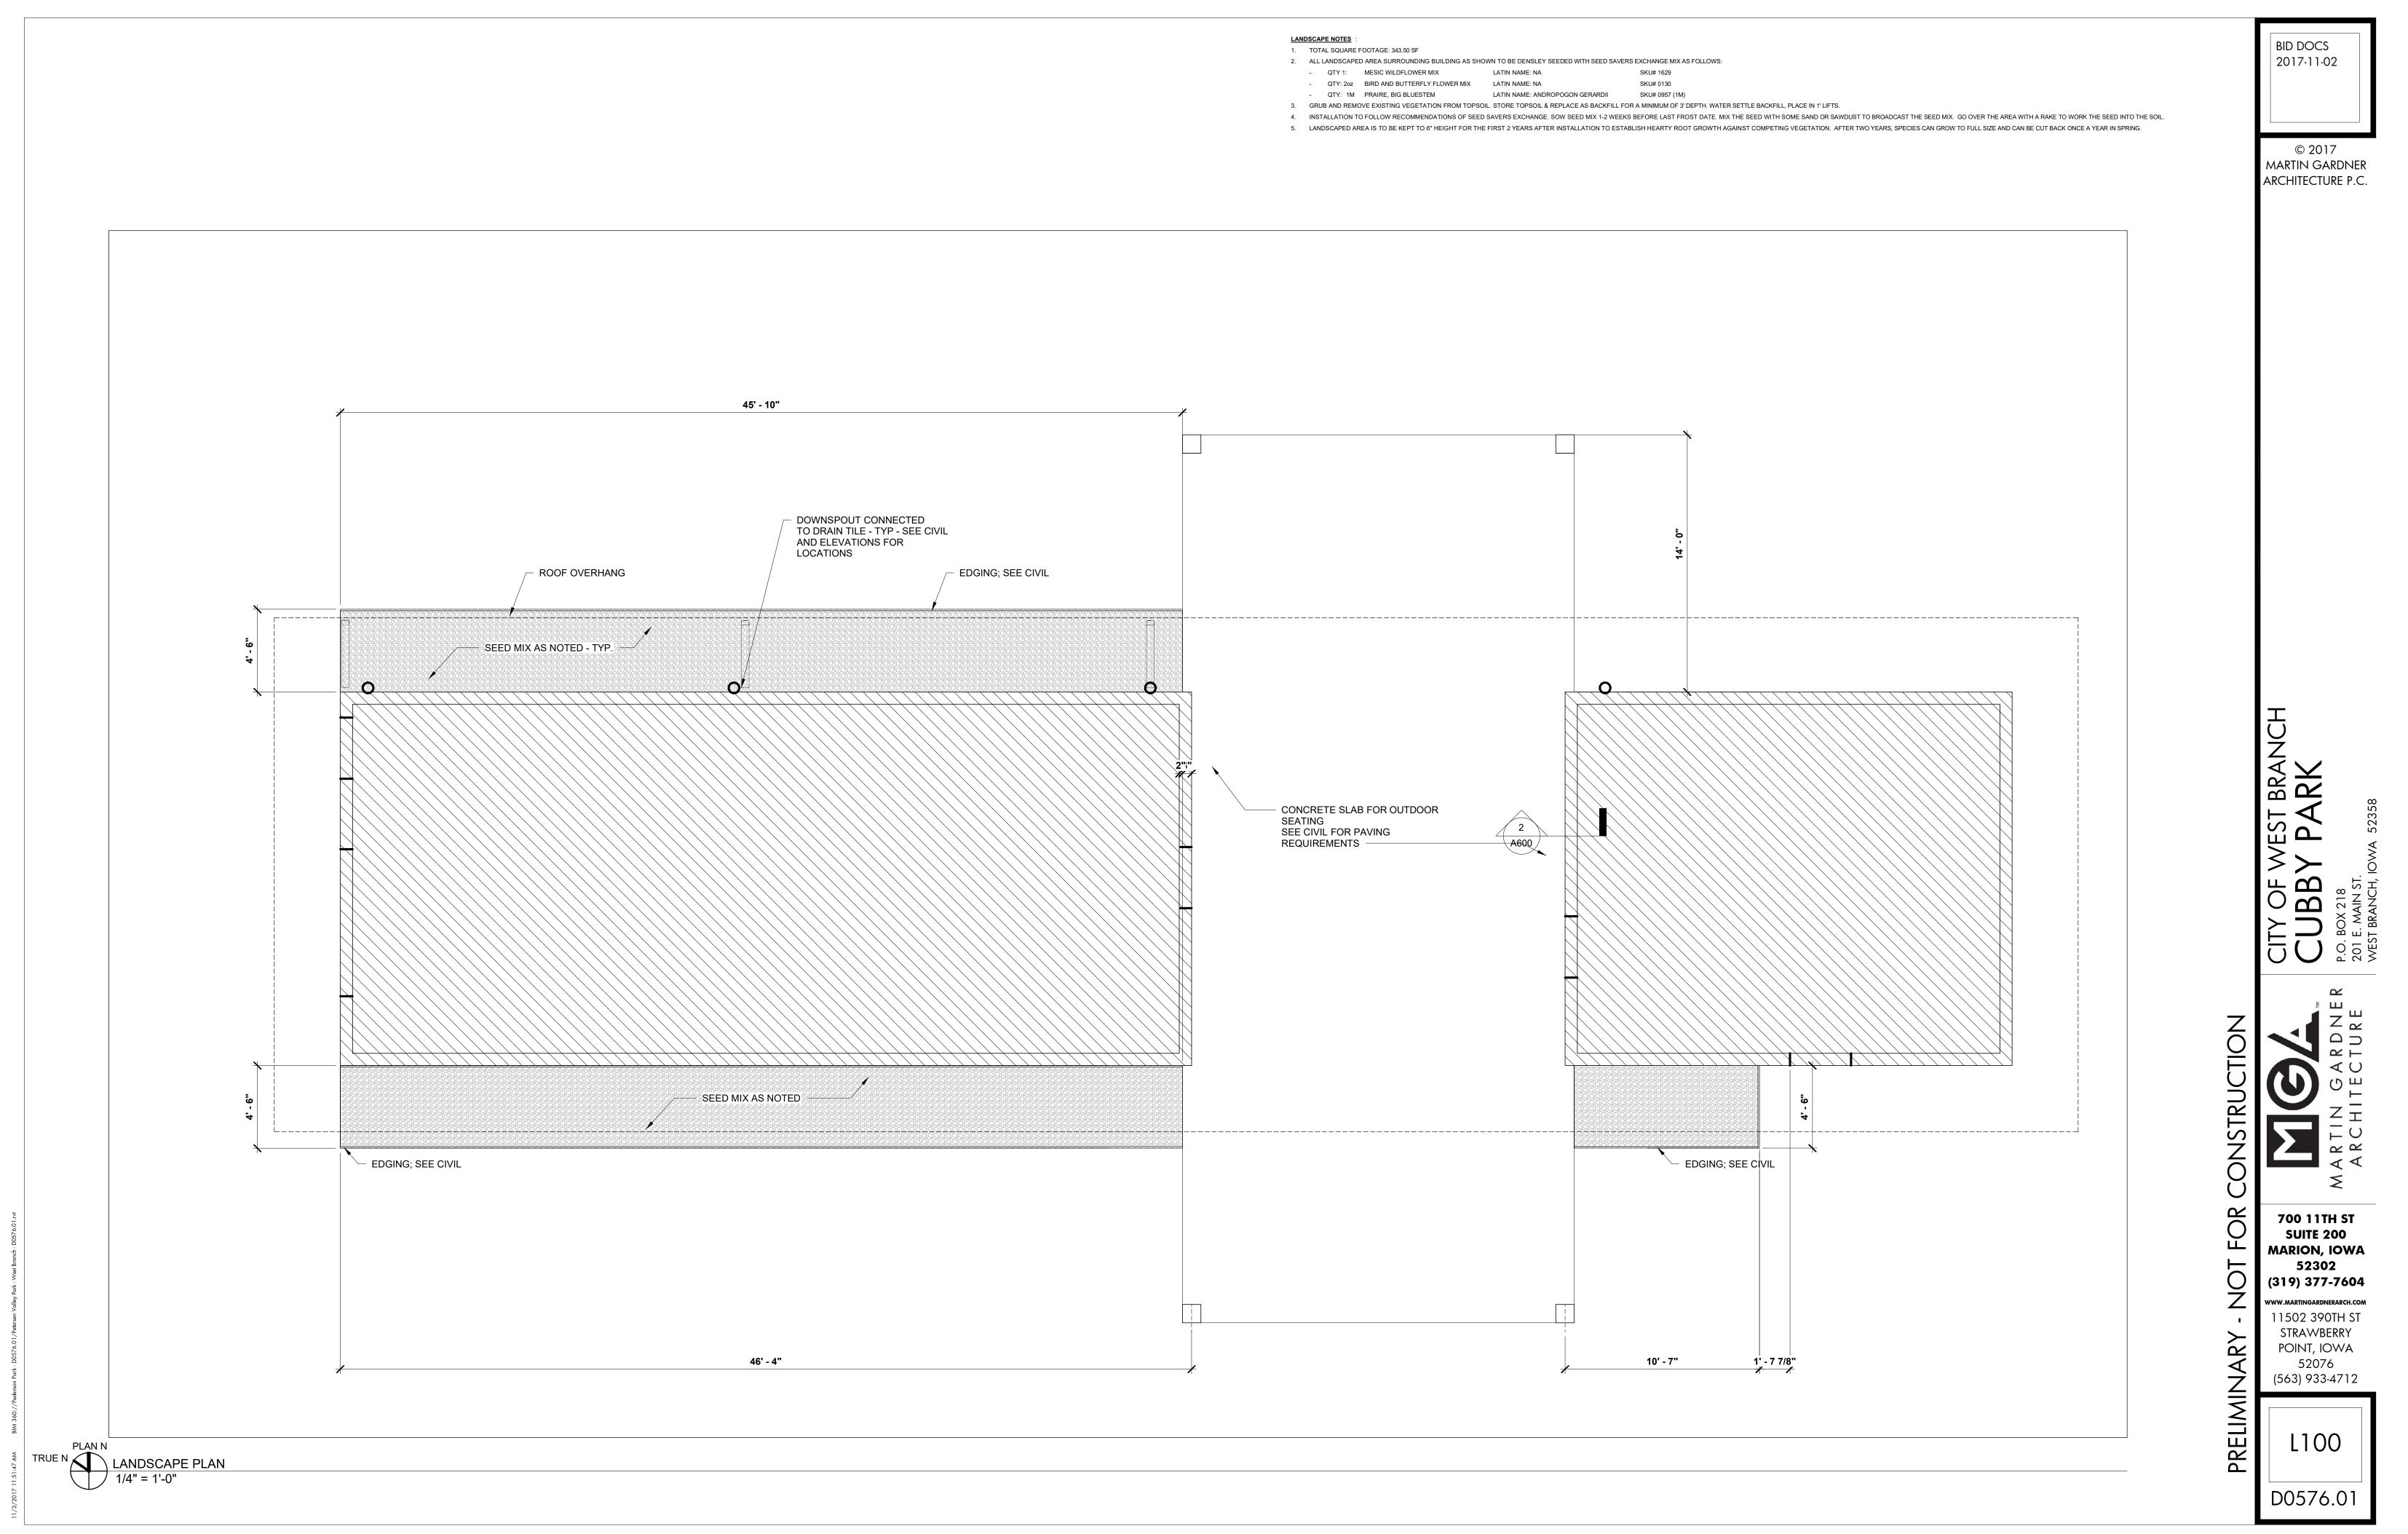 EXHAUST FAN EF-1: COOK GEMINI #GN-720 CENTRIFUGAL INLINE EXHAUST FAN WITH 6" DIA. SPRIAL DUCT TO EXTERIOR WALL AS SHOWN. 500 CFM, 1325 RPM, 3.3 SONES, 323W PER HP, 120-1-60. PROVIDE ALL DUCT ACCESSORIES TO SUSPEND EXHAUST FAN AT ELEVATION EQUAL TO BOTTOM OF TRUSS FRAMING. PROVIDE WCR6 ALUMINUM THROUGH WALL CAP WITH BIRD SCREEN. PROVIDE UNIT MOUNTED FSC SPEED CONTROL. MOUNT SPEED CONTROL ADJACENT TO ELECTRIC PANEL FOR EACH UNIT.

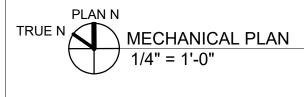

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PLUMBING FIXTURE SCHEDULE											
FIXTURE NO.	MANUFACTURER'S DESIGNATION	FIXTURE TYPE	MATERIAL	WASTE	VENT	FAUCET MFGR MODEL	MISC.	SUPPLY CW	SUPPLY HW	NOTES	
P-1	AMERICAN STANDARD 2002.014	ADA TANK WATER CLOSET	VITREOUS CHINA	3"	1-1/2"	-	-	3/4"	-	1,2	
P-2	AMERICAN STANDARD 2018.214	TANK WATER CLOSET	VITREOUS CHINA	3"	1-1/2"	-	-	3/4"	-	1	
P-3	AMERICAN STANDARD6501.511	URINAL	VITREOUS CHINA	2"	1-1/2"	-	SLOAN ROYAL 186-1.0	3/4"	-	-	
P-3.5	AMERICAN STANDARD 6501.511	ADA URINAL	VITREOUS CHINA	2"	1-1/2"	-	SLOAN ROYAL 186-1.0	3/4"	-	2	
P-4	KOHLER K-2714	DROP IN LAVATORY	VITREOUS CHINA	1-1/4"	1-1/4"	DELTA-22C131	-	1/2"	1/2"	2	
P-5	KOHLER K-1999	WALL HUNG LAVATORY	VITREOUS CHINA	1-1/4"	1-1/4"	DELTA-22C131	-	1/2"	1/2"	2	
P-6	ELKAY 3C16X20-2-18X	FOOD SERVICE SINK	STAINLESS STEEL			ELKAY LK940DS20L2H	-	1/2"	1/2"	-	
P-7	ELKAY EZH20 VRCTLDDWSK	DRINKING FOUNTAIN	STAINLESS STEEL	1-1/2"	1-1/2"	-	WITH BOTTLE FILLER	1/2"	-	-	
P-9	POWERS LFE480	THERMOSTATIC MIXING VALVE	BRASS	-	-	-	-	-	-	3	
P-10	FIAT TSB-200	MOP SINK	TERRAZZO	3"	2"	FIAT 830AA	-	3/4"	3/4"	5	
FD-1	JAY R SMITH 2005	FLOOR DRAIN	CAST IRON	3"	1-1/2"	-	-	-	-	4	


NOTES:

1. PROVIDE WITH WHITE OPEN SEAT AND SELF SUSTAINING STAINLESS STEEL CHECK HINGE.

2. MOUNT FIXTURE AT ADA REQUIRED LOW HEIGHT CONFIGURATION. 3. MIXING VALVE TO SERVE TWO LAVATORIES WHERE APPLICABLE.

4. PROVIDE WITH NICKEL BRONZE STRAINER HEAD.

5. INCLUDE FIAT 889-CC AND 832-AA MOP HANGER, HOSE AND BRACKET.

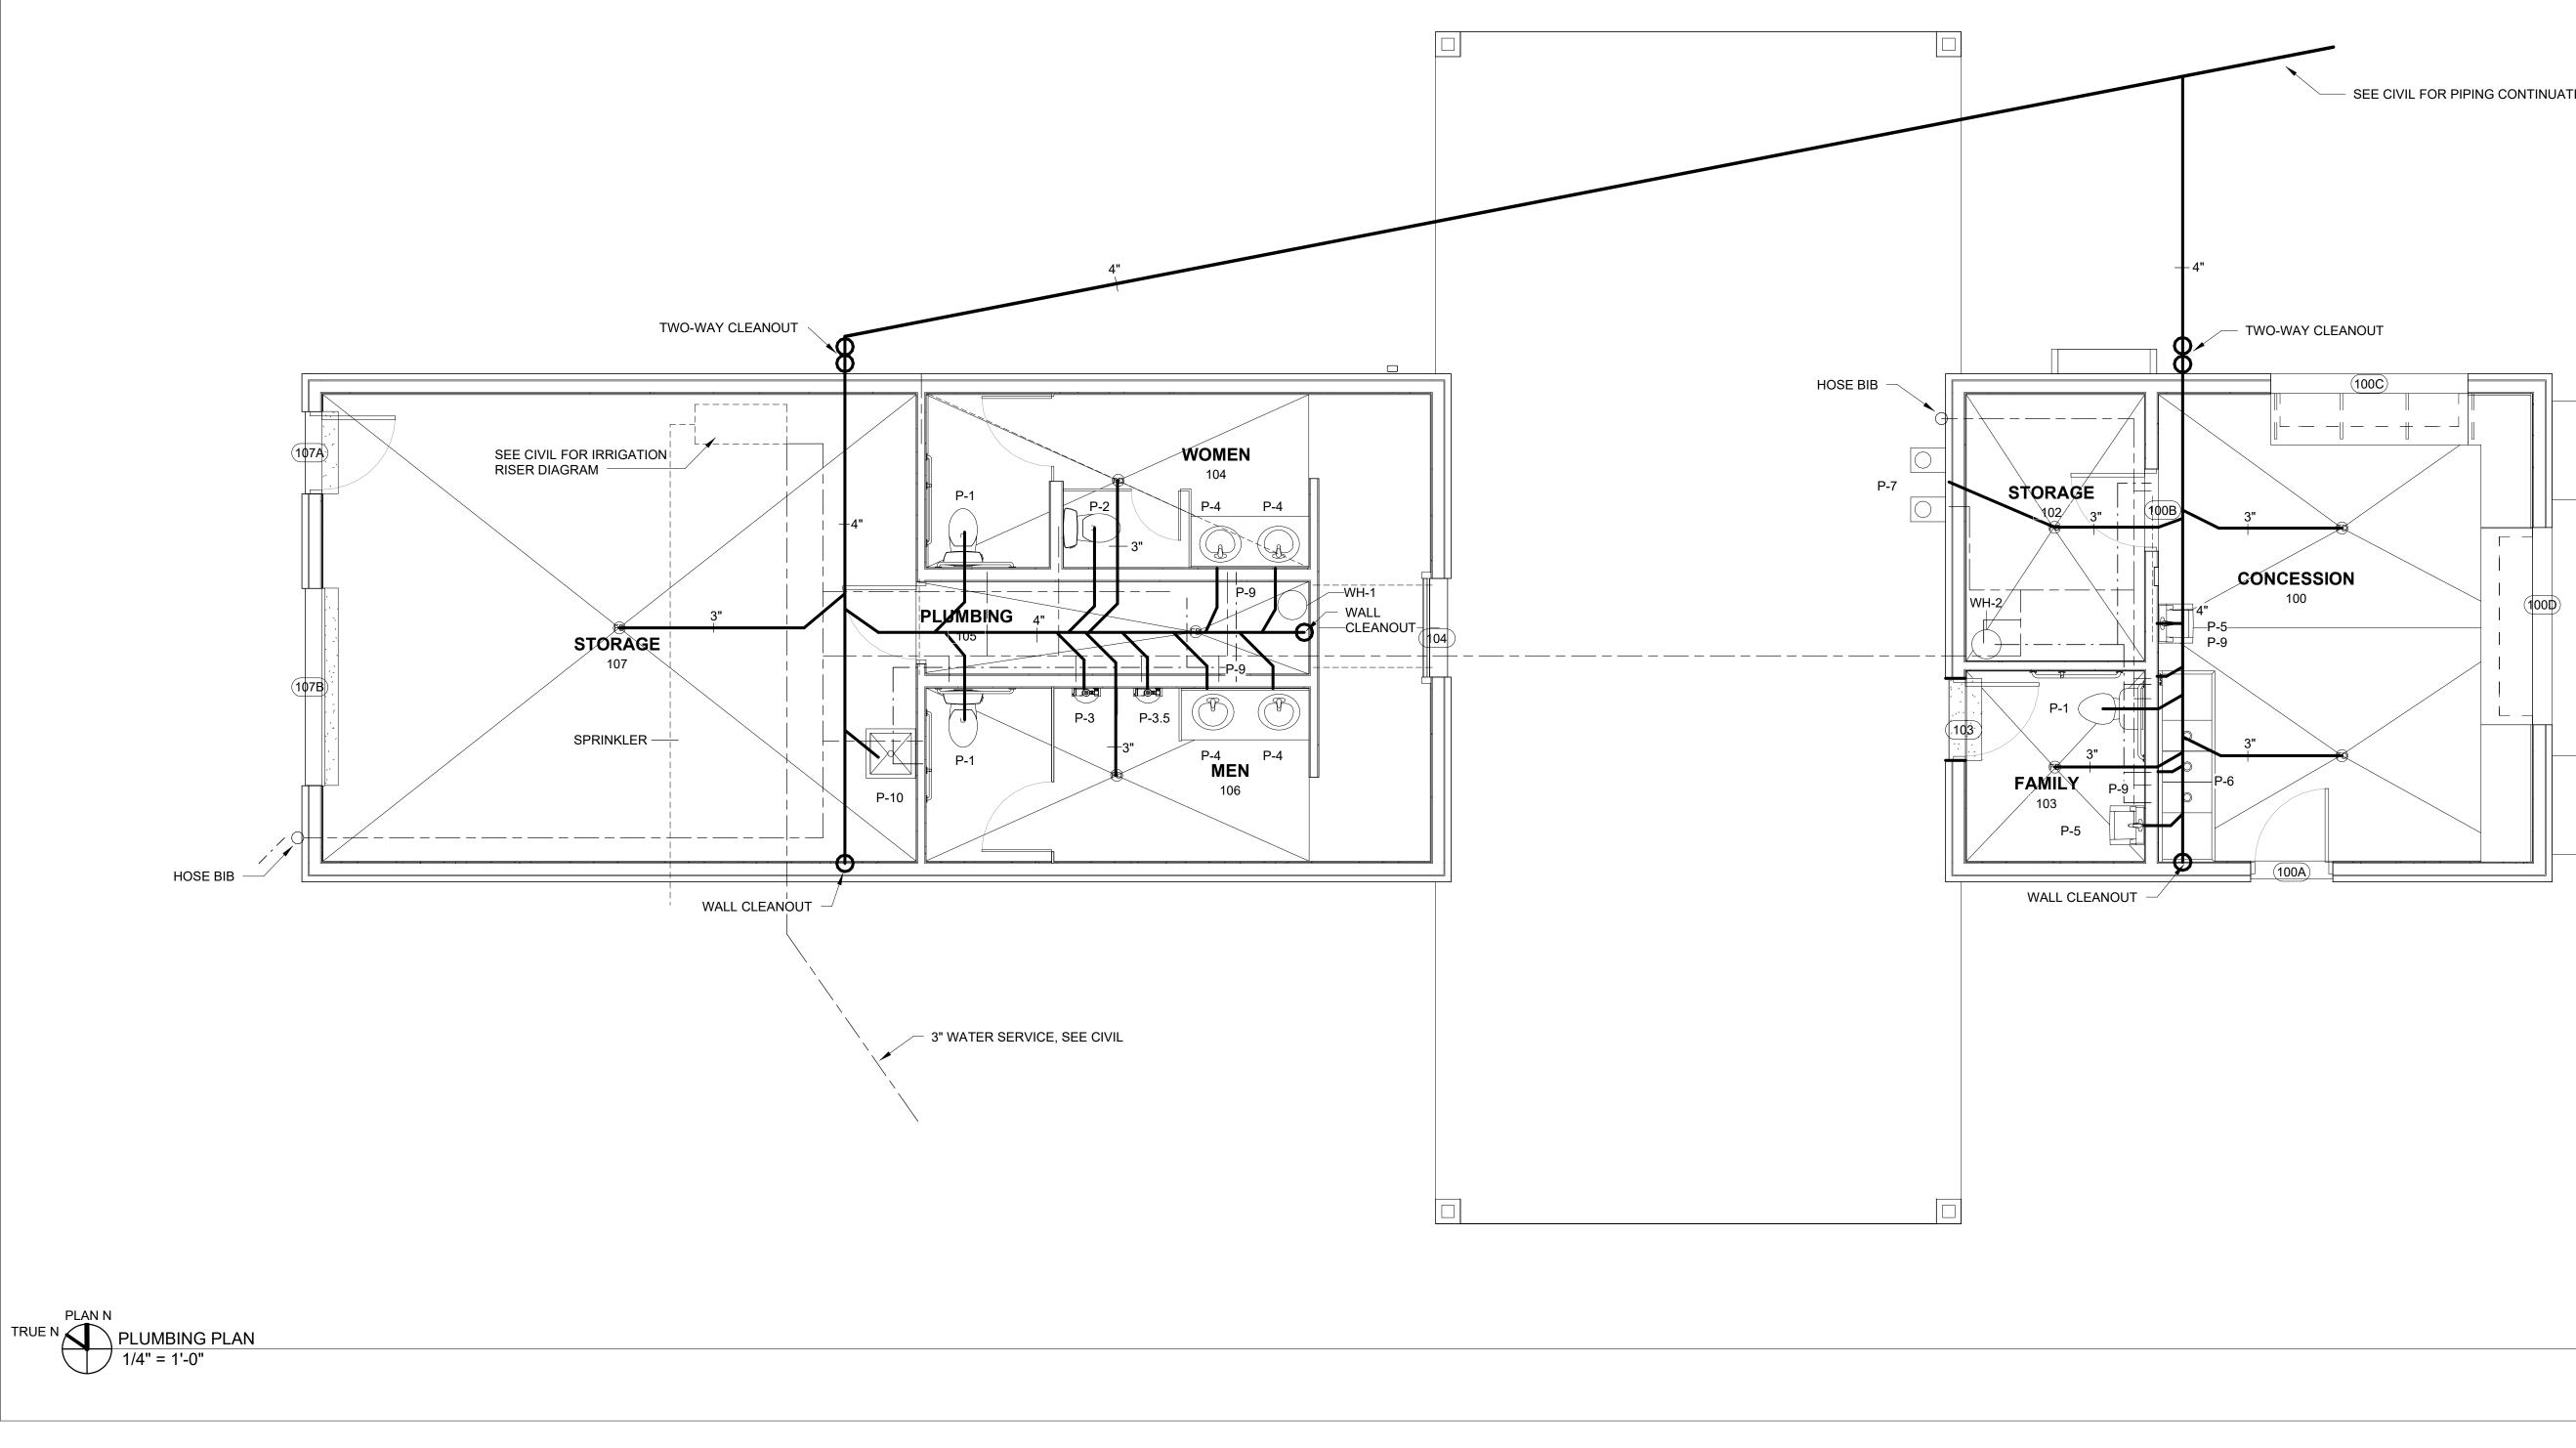

PLUBMING INSTALLATION NOTES

- 1. ALL DOMESTIC WATER PIPING SAHLL BE PLUMBED TO DRAIN TO HOSE BIBS BELOW SINKS, TO VALVE AT ENTRANCE SERVICE. THIS BUILDING WILL BE DRAINED DURING WINTER. 2. ALL ABOVE FLOOR WATER, VENT, AND WASTE PIPING MAY BE RUN TIGHT TO WALLS UNLESS NOTED OTHERWISE.
- 3. DO NOT INSTALL WATER, WASTE, OR VENT PIPING IN FRONT OF, ABOVE, OR BELOW ELECTRICAL PANEL. A 3'-0" FLOOR AREA AROUND THE PANEL IS TO REMAIN CLEAR. 4. PROVIDE BALL VALVE SHUT OFFS AT ALL FIXTURES.
- 5. WATER HEATER SCHEDULE:
- 1. WH-1: BRADFORD WHITE RE16WV6, 6 GAL. WALL HUNG ELECTRIC WATER HEATER. 120V, 1500W SINGLE PHASE. (MOUNTE WATER HEATER @ 7'-6" A.F.F.) 2. WH-2: BRADFORD WHITE RE330S6, 30 GAL. ELECTRIC WATER HEATER. 240V, 4500W SINGLE PHASE.
- 6. ALL WATER, VENT, AND ABOVE FLOOR PIPING SHALL BE RUN CONCEALED IN WALL VOIDS EXCEPT IN PLUMBING 105 OR UNLESS OTHERWISE NOTED.
- EQUIPMENT SHALL BE NEW.
- 8. LOCATE AND ARRANGE VALVES, DRAIN FITTINGS, ETC. TO BE ACCESSIBLE THROUGH LAY-IN CEILINGS OR ACCESS DOORS. PROVIDE AN ACCESS PANEL OR DOOR AS REQUIRED FOR ALL APPROVED NON-ACCESSIBLE INSTALLATIONS. COORDINATE ROUGH-IN AND FINAL LOCATIONS OF PIPING AND DUCTWORK WITH WORK OF ALL OTHER TRADES.
- 9. ALL COLD AND HOT DOMESTIC WATER PIPING TO BE INSULATED WITH 1/2" FIBERGLASS INSULATION WITH ALL SERVICE JACKET AND FACTORY INSTALLED VAPOR BARRIER. 10. ALL ABOVE GROUND SANITARY DRAIN, WASTE, & VENT PIPING SHALL BE SCH 40 PVC. PIPE JOINTS AND FITTING CONNECTIONS SHALL BE SEALED AND SOLVENT WELDED PER THE PIPE MANUFACTURER'S WRITTEN INSTRUCTIONS.
- 11. ALL UNDERGROUND SANITARY DRAIN, WASTE, & VENT PIPING SHALL BE PVC OR SERVICE WEIGHT CAST IRON. PIPE JOINTS AND FITTING CONNECTIONS SHALL BE HUB TYPE WITH PRE-FORMED NEOPRENE INSERTS.
- 12. ALL ABOVE GROUND HOT & COLD DOMESTIC WATER PIPING SHALL BE TYPE M COPPER TUBING. TUBING JOINTS AND FITTING CONNECTIONS SHALL BE SWEAT SOLDERED USING 95-5 TIN-ANTIMONY SOLDER. LEADED TYPE SOLDERS ARE NOT APPROVED. PEX PIPING ALLOWABLE WHERE ALLOWED BY CODE.
- 13. THREADED JOINTS SHALL HAVE AN APPROVED THREAD COMPOUND APPLIED TO THREADS AND THEN SHALL BE PROPERLY TIGHTENED TO ELIMINATE LEAKAGE. 14. ALL ROOF PENETRATIONS SHALL BE COORDINATED WITH THE ROOFING CONTRACTOR. ROOF PENETRATIONS SHALL BE FLASHED WITH WEATHER TIGHT, RUBBER BOOT PIPE PORTAL
- SYSTEM BY ROOF PRODUCTS & SYSTEMS CORP. (RPS) OR AN APPROVED EQUIVALENT. 15. PROVIDE DIELECTRIC UNIONS AT CONNECTIONS TO PIPING OR VALVES OF DISSIMILAR METALS. 16. PROVIDE BACKFLOW PREVENTER WITH ON EITHER SIDE FOR WINTER DISCONNECT
- 17. PLUMBING AND MECHANICAL PLANS ARE SCHEMATIC IN NATURE. DUE TO TEH SCALE OF THE DRAWINGS, NOT ALL DETAILS AND ACCESSOIRES CAN BE SHOWN. PROVIDE COMPLETE INSTALLATION OF ALL SYSTEMS.
- 18. CONSOLIDATE WASTE VENTS AS ALLOWED BY CODE FOR TEH LEAST NUMBER OF ROOF PENETRATIONS PRACTICAL 19. NO MECHANICAL SERVICES OR EQUIPMENT SHALL BE LOCATED OVER ELECTRICAL DISTRIBUTION PANELS AND SWITCHGEAR.

7. ALL WORK TO COMPLY WITH STATE AND LOCAL MECHANCIAL AND PLUMBING CODES AS WELL AS APPLICABLE NFPA CODES AND UTILITY COMPANY REGULATIONS. ALL MATERIALS AND

SEE CIVIL FOR PIPING CONTINUATION

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